KANSAS CITY AREA TRANSPORTATION AUTHORITY WITH



CITY OF KANSAS CITY, MISSOURI KANSAS CITY STREETCAR AUTHORITY PORT AUTHORITY OF KANSAS CITY, MO 💂 RIDERCAR



portkc





KANSAS CITY STREETCAR

RIVERFRONT EXTENSION

FTA FAIN # MO-2022-002-00

KCMO PROJECT No.: 89022015

ISSUED FOR BID

(T49N, R33W)

KCATA PROJECT No.: 2021-SC-3P01

DECEMBER 2022

https://www.kcata.org/about_kcata/entries/current_opportunities This work will be called Package 6 (Pkg 6) and will be posted

on KCATA's website for a General Contractor bid.

These plans have been separated into different packets to assist potential subcontractors in reviewing their potential scopes of work RIVER CHRIS GUINOTTE AVE PROPOSED RIVERFRONT EXTENSION INDEPENDENCE AVE VEHÍCLE MAINTENANCE LOCUST FACILITY I -70

MAINLINE

APPROVED BY

KCATA PROJECT MANAGER

KCATA CHIEF ENGINEER

KCMO DIRECTOR OF TRANSPORTATION

KCMO CITY ENGINEER

KCMO DIRECTOR OF PUBLIC WORKS

KANSAS CITY STREETCAR AUTHORITY

PORT AUTHORITY OF KANSAS CITY, MISSOURI

ENTRY NO.

C.D. NO. LENGTH OF PROJECT BEGINNING OF PROJECT

STA 113+00.00 NB MAINLINE STA 199+89.24 SB MAINLINE STA 150+82.51 NB MAINLINE

7,442 TF (1.4 MILES)

STA 236+48.29 SB MAINLINE 3,783 TF NB PROJECT TRACK LENGTH 3,659 TF SB

END OF PROJECT

TOTAL TRACK LENGTH

Suite 600 816-360-2700

not for construction. These plans are intended to build nterest in bidding 102 the project.

This set of plans is

SCALE FOR 22"x34" NOT TO SCALE FILENAME: GOOI.dgn CONTRACT NO.: CONTRACT NO. ***
VOLUME: DRAWING NO.: SHEET NO.:

G001

UTILITY CONTACTS

2121 East 63rd Street Kansas City, MO 64130 Mark Manion: 816-214-2322 MM256+@a++.com

Consolidated Communications 14859 W 95th Street Lenexa, KS 66215 Clarence Griffin: 913-322-9619 Clarence.Griffin@consolidated.com

Extenet Systems 3030 Warrenville Road Lisle, IL 60532 Koji Bjerke: 630-245-2075 BBjerke@extenetsystems.com

Google Fiber 908 Broadway Boulevard Kansas City, MO 64105 Greg Link : 816-605-6936 GregLink@google.com

Google Fiber 2812 W. 47th Avenue Kansas City, KS 66103 Lauren Marčucci LMarcucci@google.com

4400 E Front Street Kansas City, MO 64120 Jenny Casey: 816-347-4334 jenny.casey@evergy.com

Evergy 4400 É Front Street Kansas City, MO 64120 Marcus Robinson: 816-652-1405 Marcus.Robinson@evergy.com

Spectrum/Charter 8221 W. 119th Street Overland Park, Kansas 66213 Josh Cubley: 913-601-2504 Josh.Cubley@charter.com

Spire Energy 7500 E 35th Terrace Kansas City, MO 64129 Richi Garcia: 816-507-0713 Richi, Garcia@spireenergy, com 711 F 19th St Kansas City, MO 64108 Jerry Woodall: 913-645-5032 Jerry. Woodall@Lumen.com

Tmobile & AXON 101 Holmes Road Kansas City, MO 64106 Jason Cantrell: 913-488-8489 Jason.Cantrell@sprint.com

Unite Private Networks 7200 NW 86th Street Suite M, Kansas City, MD 64153 Harold Kalwei: 816-500-3737 Harold, Kalwei @upnfiber, com

Verizon Business 10740 Nall Avenue Suite 400 Overland Park, KS 66211 Bryan Burger: 913-344-2007 Bryan.Burger@verizon.com

Windstream Communications 10405 Baur Blvd Suite C Olivette, MO 63132 Jeremy Smiddie: 618-383-4032 Jeremy. Smiddie@windstream.com

Zayo (AboveNet, AFS) 1937 S Drumm Avenue Independence, MO 64055 Dwight Davis: 816-254-8027 Dwight, Davis@zayo, com

Vicinity Energy (Trigen) 115 Grand Boulevard Kansas City, MO 64106 Craig McNeil: 816-889-4924 Craig. Mcniel@veolia.com

Kansas City, Missouri Water Services Department: Water 4800 E 63rd Street, Kansas City, MO 64130 Reza Zonnooz: 816-513-0309 Reza.Zonnooz@kcmo.org

Kansas City, Missouri Water Services Department: Sanitary 4800 E 63rd Street, Kansas City, MO 64130 Karine Papikan: 816-513-0300 Karine, Papikian@kcmo.org

Kansas City, MO 64131-3471 Certificate of Authority: 000856

wg TITLE	DESCRIPTION	# dwg TITLE	DESCRIPTION
	GENERAL SHEETS	60 K304A SOUTHBOUND 115RE TRACK PROFILE	SB STA 211+00 TO STA 215+00
GOO1 TITLE SHEET AND LOCATION MAP		61 K305 NORTHBOUND 115RE TRACK PLAN AND PROFILE	NB STA 125+00 TO STA 129+00
GO10 INDEX OF DRAWINGS	SHEET 1	62 K305A SOUTHBOUND 115RE TRACK PROFILE	SB STA 215+00 TO STA 219+00
GO11 INDEX OF DRAWINGS	SHEET 2	63 K306 NORTHBOUND 115RE TRACK PLAN AND PROFILE	NB STA 129+00 TO STA 133+00
G012 INDEX OF DRAWINGS	SHEET 3	64 K306A SOUTHBOUND 115RE TRACK PROFILE	SB STA 219+00 TO STA 223+00
G013 INDEX OF DRAWINGS	SHEET 4		TRACK DETAILS
GO30 STANDARD ABBREVIATIONS	SHEET 1 OF 2	65 K901 TRACK SLAB DETAILS	DETAIL SHEET 1 OF 5
GO31 STANDARD ABBREVIATIONS	SHEET 2 OF 2	66 K902 TRACK SLAB DETAILS	DETAIL SHEET 2 OF 5
GO32 DCS GENERAL SYMBOLS AND ABBREVIATIONS		67 K903 TRACK SLAB DETAILS	DETAIL SHEET 3 DF 5
GO35 STANDARD SYMBOLS		68 K904 TRACK SLAB DETAILS	DETAIL SHEET 4 OF 5
GO36 TRACTION POWER SYMBOLS		69 K905 TRACK SLAB DETAILS	DETAIL SHEET 5 OF 5
G037 TRACTION POWER ABBREVIATIONS		70 K906 115 RE AND 112 TRAM RAIL SECTIONS	
GO38 SYSTEMWIDE ELECTRICAL ABBREVIATIONS AND SYMBOLS		71 K907 TRANSITION RAIL	
GO40 GENERAL NOTES		72 K908 25M/25M EQUILATERAL CONTINOUSLY CURVED FROG TURNOUT	
GO41 OCS GENERAL NOTES		73 K909 25M CONTINUOUSLY CURVED FROG TURNOUT	
G042 OCS STRUCTURAL STEEL AND CONCRET NOTES		74 K910 25M CONTINUOUSLY CURVED FROG TURNOUT	
GO43 TRACTION POWER GENERAL NOTES		75 K911 25M STRAIGHT FROG TURNOUT	
THE TOTAL POINT OF THE POINT WORLD	SURVEY CONTROL	76 K912 TURNOUT ENCAPSULATION AND SECTION DETAILS	
SV001 SURVEY CONTROL	SHEET 1 OF 2	77 K913 MANHOLE REBAR DETAIL	DETAIL SHEET 1 OF 2
SV002 SURVEY CONTROL	SHEET 2 OF 2	78 K914 MANHOLE REBAR DETAIL	DETAIL SHEET 2 OF 2
SANGE SOURCE CONTINUE	DEMOLITION PLANS	79 K915 TRACK DRAIN DETAILS	DETAIL SHEET 2 OF 2
C501 DEMOLITION PLAN		80 K916 HORIZONTAL PRECURVED RAIL LOCATION MAP	
C501 DEMOLITION PLAN	NB STA BEGIN TO STA 113+00		
C502 DEMOLITION PLAN	NB STA 113+00 TO STA 117+92	81 K917 HORIZONTAL PRECURVED RAIL DETAILS	
C503 DEMOLITION PLAN	NB STA 117+92 TO STA 121+00	82 K918 RESTRAINING RAIL	
C504 DEMOLITION PLAN	NB STA 121+00 TO STA 125+00	83 K919 INSULATED JOINT 115 RE RAIL	
C505 DEMOLITION PLAN	NB STA 125+00 TO STA 129+00	84 K920 TRACK SLAB JOINTS	
C506 DEMOLITION PLAN	NB STA 129+00 TO STA 133+00	85 K921 END OF LINE CURB STOP	
C507 DEMOLITION PLAN	NB STA 133+00 TO STA 135+50	86 K922 TRACK SLAB INFILL GRADING DETAIL	
C508 DEMOLITION PLAN	NB STA 135+50 TO STA 139+50	87 K923 112 TRAM RAIL EXPANSION JOINTS	
C509 DEMOLITION PLAN	NB STA 139+50 TO STA 143+50	88 K923A 115 RE RAIL EXPANSION JOINTS	
C510 DEMOLITION PLAN	NB STA 143+50 TO STA 147+50	89 K924 NO. 4 STRAIGHT FROG CROSSOVER	
C511 DEMOLITION PLAN	NB STA 147+50 TO END		CIVIL DETAILS
C512 DEMOLITION PLAN	2ND STREET TO VMF	90 COO1 TYPICAL SECTIONS 1	
	TRACK PLAN AND PROFILES	91 COO2 TYPICAL SECTIONS 2	
KOO1 TRACK KEY MAP		92 COO3 TYPICAL SECTIONS 3	
K101 NORTHBOUND TRACK PLAN AND PROFILE	NB STA BEGIN TO STA 113+50	93 COO4 TYPICAL DRIVEWAY DETAILS	
K101A EXISTING TRACK TIE-IN PROFILE STA -1+00 TO STA 2+50	SB TRACK PROFILE STA 199+00 TO STA 203+00	94 COO5 TYPICAL CURB DETAILS	
K102 NORTHBOUND TRACK PLAN AND PROFILE	NB STA 113+50 TO STA 117+00	95 COO6 MISCELLANEOUS CIVIL DETAILS	
K102A VMF LEAD PROFILE STA -0+50 TO STA 3+00	SB TRACK PROFILE STA 203+00 TO STA 207+00		CIVIL PLANS
K103 NORTHBOUND TRACK PLAN AND PROFILE	NB STA 117+00 TO STA 121+00	96 C101 CIVIL PLAN	NB STA BEGIN TO STA 113+00
K103A SOUTHBOUND TRACK PROFILE	SB STA 207+00 TO STA 211+00	97 C102 CIVIL PLAN	NB STA 113+00 T0 STA 117+00
K104 NORTHBOUND TRACK PLAN AND PROFILE	NB STA 121+00 TO STA 125+00	98 C103 CIVIL PLAN	NB STA 117+00 TO STA 121+00
K104A SOUTHBOUND TRACK PROFILE	SB STA 211+00 TO STA 215+00	99 C104 CIVIL PLAN	NB STA 121+00 TO STA 125+00
K105 NORTHBOUND TRACK PLAN AND PROFILE	NB STA 125+00 TO STA 129+00	100 C105 CIVIL PLAN	NB STA 125+00 TO STA 129+00
K105A SOUTHBOUND TRACK PROFILE	SB STA 215+00 TO STA 129+00	100 C105 CIVIL PLAN	NB STA 129+00 TO STA 129+00
K106 NORTHBOUND TRACK PLAN AND PROFILE	NB STA 129+00 TO STA 133+00	102 C107 CIVIL PLAN	NB STA 129+00 TO STA 135+00 NB STA 133+00 TO STA 135+50
K106A SOUTHBOUND TRACK PROFILE	SB STA 219+00 TO STA 223+00	103 C108 CIVIL PLAN	NB STA 135+50 TO STA 139+50
K107 NORTHBOUND TRACK PLAN AND PROFILE	NB STA 133+00 TO STA 135+50	104 C109 CIVIL PLAN	NB STA 139+50 TO STA 143+50
K107A SOUTHBOUND TRACK PROFILE	SB STA 223+00 TO STA 225+50	105 C110 CIVIL PLAN	NB STA 143+50 TO STA 147+50
K108 NORTHBOUND TRACK PLAN AND PROFILE	NB STA 135+50 TO STA 139+50	106 C111 CIVIL PLAN	NB STA 147+50 TO END
K108A SOUTHBOUND TRACK PROFILE	SB STA 225+50 TO STA 229+50	107 C112 CIVIL PLAN	2ND STREET TO VMF
K109 NORTHBOUND TRACK PLAN AND PROFILE	NB STA 139+50 TO STA 143+50		STREETCAR STOP DETAILS
K109A SOUTHBOUND TRACK PROFILE	SB STA 229+50 TO STA 233+50	108 C201 STREETCAR STOP	NB "RIVER MARKET NORTH"
K110 NORTHBOUND TRACK PLAN AND PROFILE	NB STA 143+50 TO STA 147+50	109 C202 STREETCAR STOP	NB/SB "RIVERFRONT"
K110A SOUTHBOUND TRACK PROFILE	SB STA 233+50 TO STA 237+50		ADA PLANS
K111 NORTHBOUND TRACK PLAN AND PROFILE	NB STA 147+50 TO STA 150+83	110 C301 ADA CURB RAMPS LAYOUT PLAN	RAMP NOTES AND DETAILS
K112 NORTHBOUND TRACK PLAN AND PROFILE	2ND STREET TO VMF	111 C302 ADA CURB RAMP STANDARD DETAILS	SHEET 1 OF 2
K113 NORTHBOUND TRACK PLAN AND PROFILE	2ND STREET TO VMF	112 C303 ADA RAMP STANDARD DETAILS	SHEET 2 OF 2
	TRACK ALIGNMENT TABLES	113 C304 3RD STREET AND GRAND BOULEVARD	GRADING PLAN
K200 TRACK ALIGNMENT TABULATION		114 C305 2ND STREET AND GRAND BOULEVARD	GRADING PLAN
K201 TRACK ALIGNMENT TABULATION		115 C306 GRADING LAYOUT PLANS	2ND STREET TO VMF
	TRACK PLANS 115RE	116 C307 GRADING LAYOUT PLANS	
K303 NORTHBOUND 115RE TRACK PLAN AND PROFILE	NB STA 117+00 TO STA 121+00	117 C308 GRADING LAYOUT PLANS	
K303A SOUTHBOUND 115RE TRACK PROFILE	SB STA 207+00 TO STA 211+00	118 C309 GRADING LAYOUT PLANS	
K304 NORTHBOUND 115RE TRACK PLAN AND PROFILE	NB STA 121+00 TO STA 125+00	119 C310 GRADING LAYOUT PLANS	

						_
REV	DATE	DESCRIPTION		DESIGNED BY	ммо	ı
						ı
				CHECKED BY	JWR	ı
				DRAWN BY	ммо	ı
						L
				CHECKED BY	JWR	ľ
				APPROVED BY	NKS	ľ
						ı
PLOT DATE:	\$DATE\$		\$TIME\$	DATE	12-23-2022	L



This set of plans is not for These plans are intended to build interest in bidding 22 the project.

ISSUED FOR BID 10450 Holmes Road Suite 600 Kansas City, MO 64131-3471 816-360-2700 Certificate of Authority: 000856 NOT FOR CONSTRUCTION

DATE: 12-23-2022 KANSAS CITY STREETCAR - RIVERFRONT EXTENSION NOT TO SCALE FILENAME: GOIO.dgn CONTRACT NO.: CONTRA SHEET 1

DRAWING NO.: SHEET NO.: G010

dwg TITLE	DESCRIPTION	#	dwg TITLE	DESCRIPTION
C311 GRADING LAYOUT PLANS	DESCRIPTION		P310 "TYPE B" SHELTER	PLANS AND ELEVATIONS
C312 GRADING LAYOUT PLANS			P311 "TYPE B" SHELTER	FLANS AND ELEVATIONS SHELTER ROOF PLAN AND RCP
C313 GRADING LAYOUT PLANS			P312 "TYPE B" SHELTER	SHELTER ENLARGED PLANS
314 GRADING LAYOUT PLANS			P313 "TYPE B" SHELTER	ENLARGED ELEVATION AND SECTION
			P361 SHELTER DETAILS	ENLARGED ELEVATION AND SECTION
7) C DOINT TABLES		105	P362 SHELTER DETAILS	
JIO PUINI TABLES	TPSS PLANS		P363 "TYPE B" SHELTER DETAILS	ADD ALTERNATE
	·			ADD ALTERNATE
401 TRACTION POWER SUBSTATION (TPSS)	RIVERFRONT GRADING PLAN		P371 MARKER SECTION AND DETAILS	
402 TRACTION POWER SUBSTATION (TPSS)	RIVERFRONT DUCTBANK PLAN		P372 MARKER SECTION AND DETAILS	
403 TRACTION POWER SUBSTATION (TPSS)	RIVERFRONT DUCTBANK PROFILE 1		P380 ELECTRICAL LIGHTING PLANS AND FIXTURE SCHEDULE	
104 TRACTION POWER AND SCADA SYSTEM	TYPICAL DUCTBANK SECTIONS		P401 PLATFORM ITS AND ELECTRICAL GENERAL NOTES	
405 TRACTION POWER SUBSTATION (TPSS)	DUCTBANK SPECIAL DETAILS		P402 PLATFORM ROADSIDE ITS 343 CABINET DIAGRAM	
406 TRACTION POWER SUBSTATION (TPSS)	TYPICAL LOW VOLTAGE 5'x7' MANHOLE DETAILS		P403 CCTV ATTACHMENT ON OCS AND LIGHT POLE DETAILS	
407 TRACTION POWER SUBSTATION (TPSS)	COMMUNICATIONS AND STRAY CURRENT PULLBOX TYPICAL DETAILS		P404 STREETCAR STOP "RIVER MARKET NORTH"	ELECTRICAL AND ITS PLAN
408 TRACTION POWER SUBSTATION (TPSS)	TYPICAL NEGATIVE RETURN DETAIL TRACK BLOCKOUT DETAIL AND TYPICAL CONDUIT STUB-UP		P405 STREETCAR STOP "RIVERFRONT"	ELECTRICAL AND ITS PLAN
409 TRACTION POWER SUBSTATION (TPSS)	TYPICAL NEGATIVE RETURN DETAIL TRACK BLOCKOUT DETAIL AND TYPICAL CONDUIT STUB-UP	DETAIL 196 F	P406 ITS TYPICAL DRAWING	TYPICAL STOP ELECTRICAL SCHEDULES AND DETAILS
·	TPSS DETAILS			PLATFORM STRUCTURAL
01 TRACTION POWER SYSTEM	MASTER SINGLE LINE DIAGRAM RIVERFRONT EXTENSION	197 P	SOO1 STRUCTURAL GENERAL NOTES	
10 TRACTION POWER	TYPICAL MAINLINE TPSS SINGLE LINE SINGLE LINE DIAGRAM	198 P	SOO2 INSPECTION - IBC 2018	
20 TRACTION POWER	TYPICAL PREFABRICATED TPSS PLAN EQUIPMENT LAYOUT PLAN		25101 "TYPE A" SHELTER - FOUNDATION AND FRAMING PLANS	S
21 TRACTION POWER	TYPICAL PREFABRICATED TPSS - EXTERIOR ELEVATIONS ELEVATION VIEW		S102 "TYPE B" SHELTER - FOUNDATION AND FRAMING PLANS	
22 TRACTION POWER	TYPICAL PREFABRICATED TPSS INTERIOR ELEVATIONS INTERIOR ELEVATIONS		2201 "TYPE A" SHELTER - SECTIONS AND ELEVATIONS	
223 TRACTION POWER	TYPICAL SURGER ARRESTER INTERIOR ELEVATIONS TYPICAL SURGER ARRESTER INTERIOR ELEVATIONS		S202 "TYPE B" SHELTER - SECTIONS AND ELEVATIONS	
30 TRACTION POWER	TPSS D1 SITE RACEWAY LAYOUT		PS301 TYPICAL CONCRETE DETAILS	
330 TRACTION POWER 332 TRACTION POWER	TPSS DI GROUND GRID LAYOUT		S302 "TYPE A" SHELTER CONCRETE DETAILS	
640 TRACTION POWER	TYPICAL DISCONNECT SWITCH ARRANGEMENT		S303 "TYPE B" SHELTER CONCRETE DETAILS	
642 TRACTION POWER	120/208V AC PANEL ADP PANEL SCHEDULE	206 P	S501 TYPICAL STEEL SECTIONS AND DETAILS	
643 TRACTION POWER	125V DC PANEL DDP PANEL SCHEDULE	\longrightarrow		PLATFORM ELEVATION PLANS
644 TRACTION POWER	TYPICAL TPSS LIGHTING SCHEMATIC		P501 "RIVER MARKET NORTH" PLATFORM	SIGNAGE LOCATION ELEVATION
45 TRACTION POWER	TYPICAL TPSS RECEPTACLES AND SMOKE DETECTOR SCHEMATIC		P502 "RIVERFRONT" PLATFORM	SIGNAGE LOCATION ELEVATION
346 TRACTION POWER	TYPICAL TPSS HVAC AND VENTILATION SCHEMATIC	209 F	P503 SIGNAGE TYPES OVERVIEW	
48 TRACTION POWER	LOGIC DIAGRAMS SYMBOLS AND LEGEND	210 F	P504 SIGNAGE TYPES OVERVIEW	
549 TRACTION POWER	SUBSTATION LOCKOUT AND ALARM LOGIC DIAGRAM	211 F	P505 SIGNAGE TYPES OVERVIEW	
650 TRACTION POWER	AC SWITCHGEAR INCOMING CUBICLE LOGIC DIAGRAM	212 F	P506 SIGNAGE TYPES OVERVIEW	
J652 TRACTION POWER	TYPICAL DC FEEDER CUBICLE LOGIC DIAGRAM SHEET 1 OF 2		P507 "RIVER MARKET NORTH" PLATFORM	WAYFINDING PLAN
1653 TRACTION POWER	TYPICAL DC FEEDER CUBICLE LOGIC DIAGRAM SHEET 2 OF 2	_		TRAFFIC SIGNAL LAYOUT PLANS
J654 TRACTION POWER	NEGATIVE AND POSITIVE DISCONNECT SWITCH LOGIC DIAGRAM	214	T100 TRAFFIC SIGNAL GENERAL NOTES	
660 TRACTION POWER	STATION CONTROL CABINET TYPICAL LAYOUT		T101 TRAFFIC SIGNAL LAYOUT PLAN	3RD STREET AND GRAND BOULEVARD
661 TRACTION POWER	RAIL TO GROUND (RZG) CABINET TYPICAL LAYOUT		101A TRAFFIC SIGNAL LAYOUT PLAN	3RD STREET AND GRAND BOULEVARD
665 TRACTION POWER	TPSS COMMUNICATIONS BLOCK DIAGRAM		101B TRAFFIC SIGNAL WIRING DIAGRAM AND PHASING	3RD STREET AND GRAND BOULEVARD
673 TRACTION POWER	TYPICAL GROUNDING DETAILS		101C TRAFFIC SIGNAL SUMMARY OF QUANTITIES	3RD STREET AND GRAND BOULEVARD
80 TRACTION POWER	D1 CONDUCTOR SCHEDULE		T102 TRAFFIC SIGNAL LAYOUT PLAN	2ND STREET AND GRAND BOULEVARD
90 TRACTION POWER	TYPICAL TPSS HMI ALARM SCREEN LAYOUT		102A TRAFFIC SIGNAL LAYOUT PLAN	2ND STREET AND GRAND BOULEVARD
91 TRACTION POWER	TYPICAL TPSS HMI CONTROL SCREEN LAYOUT		102B TRAFFIC SIGNAL WIRING DIAGRAM AND PHASING	2ND STREET AND GRAND BOULEVARD
92 TRACTION POWER	TYPICAL TPSS HMI EVENT LOG SCREEN LAYDUT		102C TRAFFIC SIGNAL SUMMARY OF QUANTITIES	2ND STREET AND GRAND BOULEVARD
93 TRACTION POWER	TYPICAL TPSS HMI NETWORK STATUS SCREEN LAYOUT		T103 TRAFFIC SIGNAL LAYOUT PLAN	BERKLEY PARKWAY / RIVERFRONT DRIVE
94 TRACTION POWER	TYPICAL SUBSTATION FOUNDATION DETAIL		103B TRAFFIC SIGNAL WIRING DIAGRAM AND PHASING	BERKLEY PARKWAY / RIVERFRONT DRIVE
95 TRACTION POWER	TYPICAL PAD MOUNTED DISCONNECT SWITCH FOUNDATION DETAILS	₹ 225 T	103C TRAFFIC SIGNAL SUMMARY OF QUANTITIES	BERKLEY PARKWAY / RIVERFRONT DRIVE
1 1 1 1 1 1 1 1 1 1 1 1 1 1 1 1 1 1 1 1	DRAINAGE PLANS			TRAFFIC SIGNAL DETAILS
	NB STA BESTA TO STATISTICS		T201 TRAFFIC SIGNAL DETAILS	CROSS SPAN JOINT USE TRAFFIC/OCS POLE
O2 DRAINAGE PLAN	NB STA 113+00 TO STA 117+00		T202 TRAFFIC SIGNAL DETAILS	AUXILIARY CABINET MOUNTING DETAIL
03 DRAINAGE PLAN	NB STA 117+00 TO STA 121+00	228 1	T203 TRAFFIC SIGNAL DETAILS	TRAFFIC SIGNAL SYMBOLS
O6 DRAINAGE PLAN	NB STA 129+00 TO STA 133+00		T204 TRAFFIC SIGNAL DETAILS	SIGNAL HEAD DETAILS
D9 DRAINAGE PLAN	NB STA 139+50 TO STA 143+50		T205 TRAFFIC SIGNAL DETAILS	SIGNAL MAST ARM DETAILS
10 DRAINAGE PLAN	NB STA 143+50 TO STA 147+50		T206 TRAFFIC SIGNAL DETAILS	SIGNAL CONCRETE BASE DETAILS
11 DRAINAGE PLAN	NB STA 147+50 TO END		T207 TRAFFIC SIGNAL DETAILS	SIGNAL PULL BOX DETAILS
01 MISCELLANEOUS DRAINAGE DETAILS	NO 378 171 130 10 END		T208 TRAFFIC SIGNAL DETAILS	SIGNAL PULL BOX DETAILS
OT MISOCCEANEOUS DIVATINAGE DETAILS	PLATFORMS		T209 TRAFFIC SIGNAL DETAILS	SIGNAL PTZ CAMERA INSTALL DETAILS
01 "PIVER MARKET NORTH"	PLATFORM PLAN		T210 TRAFFIC SIGNAL DETAILS	PEDESTRIAN PUSHBUTTON POLE DETAILS
01 "RIVER MARKET NORTH"				
102 "RIVERFRONT"	PLATFORM PLAN	236 7	T211 TRAFFIC SIGNAL DETAILS	PEDESTRIAN PUSHBUTTON POLE DETAILS
O1 "RIVER MARKET NORTH"	PLATFORM ELEVATION			SIGNING AND STRIPING PLANS
202 "RIVERFRONT"	PLATFORM ELEVATION		SOO1 SIGNING AND STRIPING	GENERAL NOTES
203 PLATFORM SITE DETAILS			S100 SIGNING AND STRIPING PLAN	5TH TO 3RD STREET
204 PLATFORM SEAT WALL DETAILS			S101 SIGNING AND STRIPING PLAN	NB STA BEGIN TO STA 113+00
				1 NO STA 447-00 TO STA 447-00
302 "TYPE A" SHELTER	PLANS AND ELEVATIONS		5102 SIGNING AND STRIPING PLAN 5103 SIGNING AND STRIPING PLAN	NB STA 113+00 TD STA 117+00 NB STA 117+00 TD STA 121+00

REV	DATE	DESCRIPTION	DESIGNED BY	ммо
			CHECKED BY	JWR
			DRAWN BY	ммо
			CHECKED BY	JWR
			APPROVED BY	NKS
PLOT DATE:	\$DATF\$	\$TIMF\$	L	12 27 2022

RideKC STREETCAR

This set of plans is not for construction.
These plans are intended to build interest in bidding 22 the project.

ISSUED FOR BID 10450 Holmes Road Suite 600 Kansas City, MO 64131-3471 816-360-2700 Certificate of Authority: 000856 NOT FOR CONSTRUCTION

DATE: 12-23-2022 KANSAS CITY STREETCAR - RIVERFRONT EXTENSION

| SCALE FOR 22'x34': NOT TO SCALE FILENAME: GOILdgo CONTRACT NO.: CONTRACT NO.: CONTRACT NO.: CONTRACT NO.: VOLUME: VOLUME: SHEET 2

DRAWING NO.: SHEET NO.:

dwg TITLE	DESCRIPTION	# dwg TITLE	DESCRIPTION
S104 SIGNING AND STRIPING PLAN	NB STA 121+00 TO STA 125+00	302 ST308 BID ALTERNATE - 115RE JOINTS FINGER JOINT MODIFICATION PLAN - PIER 8	
S105 SIGNING AND STRIPING PLAN	NB STA 125+00 TO STA 129+00	303 ST309 BID ALTERNATE - 115RE JOINTS FINGER JOINT MODIFICATION DETAILS	
S106 SIGNING AND STRIPING PLAN	NB STA 129+00 TO STA 133+00	304 ST310 BID ALTERNATE - 115RE JOINTS STRIP SEAL REMOVAL AND REPLACEMENT PLAN - F	IERS 11 & 12
S107 SIGNING AND STRIPING PLAN	NB STA 133+00 TO STA 135+50	305 ST311 BID ALTERNATE - 115RE JOINTS STRIP SEAL DETAILS	
S108 SIGNING AND STRIPING PLAN	NB STA 135+50 TO STA 139+50	306 ST312 BID ALTERNATE - 115RE JOINTS TYPICAL SLAB SECTIONS AND DETAILS	
S109 SIGNING AND STRIPING PLAN	NB STA 139+50 TO STA 143+50	307 ST313 BID ALTERNATE - 115RE JOINTS SLAB REINFORCING - PIER 2	
S110 SIGNING AND STRIPING PLAN	NB STA 143+50 TO STA 147+50	308 ST314 BID ALTERNATE - 115RE JOINTS SLAB REINFORCING - PIER 5	
S111 SIGNING AND STRIPING PLAN	NB STA 147+50 TO END	309 ST315 BID ALTERNATE - 115RE JOINTS SLAB REINFORCING - PIER 8	
S112 SIGNING AND STRIPING PLAN	2ND STREET TO VMF	310 ST316 BID ALTERNATE - 115RE JOINTS SLAB REINFORCING - PIER 11	
S113 PAVEMENT MARKING TABULATION		311 ST317 BID ALTERNATE - 115RE JOINTS SLAB REINFORCING - PIER 12	
S114 SIGN REMOVAL TABULATION	-	312 ST318 BID ALTERNATE - 115RE JOINTS BILL OF REINFORCING STEEL (SLAB)	
S115 SIGN PANEL DETAILS		313 ST319 BID ALTERNATE - 115RE JOINTS BILL OF REINFORCING STEEL (SLAB)	
	IGHTING PLANS	314 ST320 BID ALTERNATE - 115RE JOINTS BILL OF REINFORCING STEEL (SLAB)	
LOO1 GENERAL LIGHTING NOTES AND SYMBOL LEGEND		315 ST321 BID ALTERNATE - 115RE JOINTS EAST BARRIER RAIL AT PIER 2, 5 & 8	
L101 LIGHTING PLAN	NB STA BEGIN TO STA 113+00	316 ST322 BID ALTERNATE - 115RE JOINTS EAST BARRIER RAIL AT PIER 11 & 12	
L102 LIGHTING PLAN	NB STA 113+00 TO STA 117+00	317 ST323 BID ALTERNATE - 115RE JOINTS EAST BARRIER DETAILS	
L103 LIGHTING PLAN	NB STA 117+00 TO STA 121+00	318 ST324 BID ALTERNATE - 115RE JOINTS WEST BARRIER RALL AT PIER 2, 5 & 8	
L104 LIGHTING PLAN	NB STA 121+00 TO STA 125+00	319 ST325 BID ALTERNATE - 115RE JOINTS WEST BARRIER RAIL AT PIER 11 & 12	
L105 LIGHTING PLAN	NB STA 125+00 TO STA 125+00	319 51325 BID ALTERNATE - 115RE JUINTS WEST BARRIER DETAILS 320 ST326 BID ALTERNATE - 115RE JUINTS WEST BARRIER DETAILS	
L106 LIGHTING PLAN	NB STA 129+00 TO STA 133+00	321 ST328 BID ALTERNATE - TISKE JUINIS WEST BARRIER DETAILS 321 ST328 BID ALTERNATE - 115RE JOINTS BARRIER DETAILS 1	
L106 LIGHTING PLAN		321 S1329 BID ALTERNATE - 115RE JOINTS BARRIER DETAILS 2	
	NB STA 133+00 TO STA 135+50		
L108 LIGHTING PLAN	NB STA 135+50 TO STA 139+50	323 ST330 BID ALTERNATE - 115RE JOINTS BARRIER DETAILS 3	
L109 LIGHTING PLAN	NB STA 139+50 TO STA 143+50	324 ST331 BID ALTERNATE - 115RE JOINTS EAST BARRIER BAR LIST	
L110 LIGHTING PLAN	NB STA 143+50 TO STA 147+50	325 ST332 BID ALTERNATE - 115RE JOINTS WEST BARRIER BAR LIST	CONTROL BLANC
L111 LIGHTING PLAN	NB STA 147+50 TO END		CONTROL PLANS
L112 LIGHTING PLAN	2ND STREET TO VMF	326 EC101 EROSION CONTROL PLAN	NB STA 135+50 TO STA 139+50
	GHTING DETAILS	327 EC102 EROSION CONTROL PLAN	NB STA 139+50 TO STA 143+50
L300 STREET LIGHTING DETAILS		328 EC103 EROSION CONTROL PLAN	NB STA 143+50 TO STA 147+50
L301 STREET LIGHTING DETAILS		329 EC104 EROSION CONTROL PLAN	NB STA 147+50 TO END
L302 POWER AND LIGHTING DETAILS			HNICAL SHEETS
L303 POWER AND LIGHTING DETAILS		330 YOO4 TECHNICAL SHEETS CONDUCTOR PARTICULARS	
L304 STREET LIGHTING SCHEDULES		331 Y005 TECHNICAL SHEETS VERTICAL ELECTRICAL CLEARANCE REQUIREMENTS	
L305 STREET LIGHTING SCHEDULES		332 Y006 TECHNICAL SHEETS PANTOGRAPH SECURITY	
L306 WIRING SCHEMATIC DETAILS		333 YOO7 TECHNICAL SHEETS TYPICAL OFFSET AND STAGGER DETAILS	
L307 WIRING SCHEMATIC DETAILS		334 YOO8 TECHNICAL SHEETS INSTALLATION TENSION CHART	
LA	NDSCAPE PLANS	335 YOO9 TECHNICAL SHEETS ALONG TRACK MOVEMENT CHART	
LS101 LANDSCAPE PLAN	BERKLEY PARK - 1	336 YO10 TECHNICAL SHEETS VERTICAL AND RADIAL LOADS	
LS102 LANDSCAPE PLAN	BERKLEY PARK - 2	337 YO11 TYPICAL ARRANGEMENTS TYPICAL DVERLAP ARRANGEMENT	
LS103 LANDSCAPE PLAN	BERKLEY PARK - 3	338 YO12 TYPICAL ARRANGEMENTS AT GRAND BOULEVARD VIADUCT	
LS104 LANDSCAPE PLAN	GRAND BOULEVARD	339 YO13 TYPICAL ARRANGEMENTS AT APPROACH STRUCTURES	
LS201 LANDSCAPE DETAILS		340 Y021 STRUCTURAL DETAILS TYPICAL POLE DETAIL	
	E DETAILS 112TRAM	341 YO23 STRUCTURAL DETAILS STREETLIGHT POLE DETAIL	
ST100 BASE BID - 112TRAM JOINTS GENERAL NOTES	DETAILS TIZINAM	342 YO25 STRUCTURAL DETAILS DOWN GUY ASSEMBLY	
ST101 BASE BID - 112TRAM JOINTS DECK MILL AND OVERLAY LIMITS	1 OF 3	342 1023 STRUCTURAL DETAILS DUMN OUT ASSEMBLY 343 YOS1 STRUCTURAL DETAILS TYPICAL FOUNDATION DETAIL	
STIDE BASE BID - ITZTRAM JUINTS DECK MILL AND OVERLAY LIMITS STIDE BASE BID - 112TRAM JUINTS DECK MILL AND OVERLAY LIMITS	2 OF 3		
		344 Y033 STRUCTURAL DETAILS STREETLIGHT POLE FOUNDATION DETAIL	
ST103 BASE BID - 112TRAM JOINTS DECK MILL AND OVERLAY LIMITS	3 OF 3	345 YO34 STRUCTURAL DETAILS 2 FT DIAMETER FOUNDATION DETAIL	
ST104 BASE BID - 112TRAM JOINTS MODIFIED FINGER JOINT PLAN	PIERS 2 AND 5	346 Y035 STRUCTURAL DETAILS ROCK SOCKET AND DOWN GUY FOUNDATION DETAILS	
ST105 BASE BID - 112TRAM JOINTS MODIFIED FINGER JOINT PLAN	PIER 8	347 Y036 STRUCTURE DETAIL TYPICAL SPREAD FOOTING FOUNDATION DETAIL	AUGGE - AG A
ST106 BASE BID - 112TRAM JOINTS FINGER JOINT MODIFICATION DETAILS		348 Y037 POLE INSTALLATION DETAILS AT GRAND BOULEVARD VIADUCT	SHEET 1 OF 2
ST107 BASE BID - 112TRAM JOINTS STRIP SEAL PLAN	PIERS 11 AND 12	349 YO38 POLE INSTALLATION DETAILS AT GRAND BOULEVARD VIADUCT	SHEET 2 OF 2
ST108 BASE BID - 112TRAM JOINTS STRIP SEAL DETAILS		350 Y039 STRUCTURAL DETAILS ANCHOR BOLT DETAIL	
ST109 BASE BID - 112TRAM JOINTS BRIDGE TYPICAL SECTIONS		351 Y041 BRACKET ARM ASSEMBLIES SINGLE PIPE BRACKET ARM	
	TRACK DRAIN DETAILS	352 Y042 BRACKET ARM ASSEMBLIES DOUBLE PIPE BRACKET ARM	
ST201 PLAN VIEW - ABUTMENT 2 - TRACK DRAIN		353 YO43 BRACKET ARM ASSEMBLIES OVERLAP SINGLE PIPE BRACKET ARM	
ST202 APPROACH SLAB EXPANSION JOINT DRAIN DETAIL		354 Y044 BRACKET ARM ASSEMBLIES POLE CLAMP DETAILS	
ST203 EXISTING MSE WALLS		355 Y045 BRACKET ARM ASSEMBLIES BRACKET ARM POLE SOCKET	
ST204 TRACK SLAB DETAIL - OVER UTILITY VAULT		356 YO46 BRACKET ARM ASSEMBLIES OVERLAP BRACKET ARM MOUNTING BRACKET DETAIL	
	GE DETAILS 115RE	357 YO47 BRACKET ARM ASSEMBLIES SECTION INSULATOR SUPPORT	
ST300 BID ALTERNATE - 115RE JOINTS GENERAL NOTES		358 YO51 SPAN WIRE ARRANGEMENTS CROSS SPAN DETAILS	
ST301 BID ALTERNATE - 115RE JOINTS MILL AND OVERLAY LIMITS - ABUT 1		359 YO52 SPAN WIRE ARRANGEMENTS HEADSPAN ASSEMBLY	
ST302 BID ALTERNATE - 115RE JOINTS CONCRETE REMOVAL - PIER 2		360 Y056 REGISTRATION ASSEMBLIES PULLOVER ASSEMBLIES	SHEET 1 OF 2
ST303 BID ALTERNATE - 115RE JOINTS CONCRETE REMOVAL - PIER 5		361 YO57 REGISTRATION ASSEMBLIES PULLOVER ASSEMBLIES	SHEET 2 OF 2
ST304 BID ALTERNATE - 115RE JOINTS CONCRETE REMOVAL - PIER 8		362 YOS8 REGISTRATION ASSEMBLIES PENDULUM SUSPENSION ASSEMBLIES	wheel a will be
ST305 BID ALTERNATE - 115RE JOINTS CONCRETE REMOVAL - PIER 11 ST306 BID ALTERNATE - 115RE JOINTS CONCRETE REMOVAL - PIER 12		363 Y059 REGISTRATION ASSEMBLIES SUSPENSION ASSEMBLIES	

REV	DATE DESCRIPTION	DESIGNED BY MMO	This set of plans is	ISSUED FOR BID DATE: 12-23-2022	KANSAS CITY STREETCAR - RIVERFRONT EXTENSION	SCALE FOR 22"×34": NOT TO SCALE
		CHECKED BY JWR DRAWN BY MMO	deKC not for construction.	HDR Engineering, Inc.		FILENAME: G0I2.dgn CONTRACT NO.:
		STI	TREETCAR These plans are	10450 Holmes Road Suite 600	INDEX OF DRAWINGS	CONTRACT NO. *** VOLUME:
		CHECKED BY JWR APPROVED BY NKS	intended to build interest in bidding 22	Kansas City, MO 64131-3471 816-360-2700 Certificate of Authority 000856	CHEET 2	DRAWING NO.: SHEET NO.:
PLOT DATE	: \$DATE\$	\$TIME\$ DATE 12-23-2022	JAN the project, 2R	NOT FOR CONSTRUCTION		G012 4

# dwg TITLE	DESCRIPTION	# dwg		DESCRIPTION
364 YO61 IN-SPAN ASSEMBLIES JUMPER ASSEMBLIES			COMMUNICATIONS DETAILS	RING DIAGRAM SHEET 4
365 Y062 IN-SPAN ASSEMBLIES SECTION INSULATOR ASSEMBLY			COMMUNICATIONS DETAILS	RING DIAGRAM SHEET 5
366 YOG3 IN-SPAN ASSEMBLIES TYPICAL SPLICE DETAILS			COMMUNICATIONS DETAILS	3RD ST SPLICE
367 YO64 IN-SPAN ASSEMBLIES SPAN SPACER AND CROSS CONTACT WIRE CLAMP	P ASSEMBLIES	430 Z621		3RD ST SPLICE INSET
368 YO65 IN-SPAN ASSEMBLIES CONTACT WIRE PROTECTION BOARD			COMMUNICATIONS DETAILS	2ND ST SPLICE
369 YOG6 SWITCHING AND FEEDER ASSEMBLIES FEEDER TAP DETAILS			COMMUNICATIONS DETAILS	SUB STATION SPLICE
370 Y067 SWITCHING AND FEEDER ASSEMBLIES SURGE ARRESTER DETAILS			COMMUNICATIONS DETAILS	BERKLEY PKWY SPLICE
371 Y068 SECTIONALIZING DIAGRAM			COMMUNICATIONS DETAILS	RIVERFRONT SPLICE DIAGRAM
372 Y069 POLE GROUND WIRE INSTALLATION GRAND BOULEVARD VIADUCT PIERS 373 Y070 SWITCHING FEEDER ASSEMBLIES FEEDER TAP DETAILS	2		COMMUNICATIONS DETAILS	RIVERFRONT STATION SPLICE
			ITS CONDUIT HANGER DETAILS	
374 YO71 TERMINATION ASSEMBLIES FIXED TERMINATION ASSEMBLY	I V		CONDUIT TRANSITION DETAIL	
375 Y072 TERMINATION ASSEMBLIES SPRING TENSIONER TERMINATION ASSEMBL 376 Y081 MISCELLANEOUS POLE NUMBERING DETAIL	L Y		ITS CONDUIT TRANSITION BOX DETAIL ITS CONDUIT EXPANSION/DEFLECTION POINT	
377 Y092 CROSS SECTION HEART OF AMERICA BRIDGE			ITS CONDUIT RISER	
378 Y093 PROFILES HEART OF AMERICA BRIDGE	SHFFT 1 OF 2	440 2631	IIS CONDUIT RISER	TRAIN CONTROL PLANS
379 Y094 PROFILES HEART OF AMERICA	SHEET 2 OF 2	441 N101	TRAIN CONTROL PLAN	
380 Y097 CROSS SECTION OCS FEEDING POINT	SHEEL 2 UF 2		TRAIN CONTROL PLAN	3RD & GRAND 2ND & GRAND
381 Y111 STRUCTURE SCHEDULE POLE AND FOUNDATION SCHEDULE	SHEET 1 OF 2		TRAIN CONTROL PLAN	
382 Y112 STRUCTURE SCHEDULE POLE AND FOUNDATION SCHEDULE 382 Y112 STRUCTURE SCHEDULE POLE AND FOUNDATION SCHEDULE	SHEET 1 OF 2 SHEET 2 OF 2		TRAIN CONTROL PLAN	FRONT & BERKLEY RIVERFRONT
202 1112 STAUCTURE SCHEDULE FULE AND FUUNDATION SCHEDULE	OCS LAYOUT PLANS		TRAIN CONTROL PLAN	VMF
383 V108 KEY MAD	GUS LATOUT FLANS	1443 NIUS	INAIN CONTROL FLAN	TRAIN SIGNALING
383 Y198 KEY MAP 384 Y199 MASTER OVERLAP CHART		446 NEOO	TRAIN CONTROL TRACK AND CABLE PLAN	3RD & GRAND
385 Y201 OCS LAYOUT PLAN	NB STA BEGIN TO STA 113+00		TRAIN CONTROL TRACK AND CABLE PLAN	2ND & GRAND
386 Y202 OCS LAYOUT PLAN	NB STA 113+00 TO STA 117+00		TRAIN CONTROL TRACK AND CABLE PLAN	FRONT STREET
387 Y203 OCS LAYOUT PLAN	NB STA 117+00 TO STA 121+00		TRAIN CONTROL TRACK AND CABLE PLAN TRAIN CONTROL TRACK AND CABLE PLAN	RIVERFRONT
388 Y204 OCS LAYOUT PLAN	NB STA 121+00 TO STA 125+00		TRAIN CONTROL TRACK AND CABLE PLAN TRAIN CONTROL ROUTE AND ASPECT CHART	3RD & GRAND
389 Y205 OCS LAYOUT PLAN	NB STA 125+00 TO STA 129+00		TRAIN CONTROL ROUTE AND ASPECT CHART	2ND & GRAND
390 Y206 OCS LAYOUT PLAN	NB STA 129+00 TO STA 133+00		TRAIN CONTROL ROUTE AND ASPECT CHART	RIVERFRONT
391 Y207 OCS LAYOUT PLAN	NB STA 133+00 TO STA 135+50		TRAIN CONTROL TURNOUT BONDING	KIYEM KONT
392 Y208 OCS LAYOUT PLAN	NB STA 135+50 TO STA 139+50		TRAIN CONTROL	TYPICAL SIGNAL CASE LAYOUT RELAY CASE
393 Y209 OCS LAYOUT PLAN	NB STA 139+50 TO STA 143+50		TRAIN CONTROL	TYPICAL SIGNAL CASE FOUNDATION AND GROUNDING DETAILS
394 Y210 OCS LAYOUT PLAN	NB STA 143+50 TO STA 147+50		TRAIN CONTROL	TYPICAL TWC LOOP INSTALLATION EMBEDDED TRACK
395 Y211 OCS LAYOUT PLAN	NB STA 147+50 TO END		TRAIN CONTROL	CABLE / CONDUIT SCHEDULE
396 Y212 OCS BRIDGE GROUNDING LAYOUT PLAN	STA 117+00 TO STA 121+00		TRAIN CONTROL	CABLE / CONDUIT SCHEDULE
397 Y213 OCS BRIDGE GROUNDING LAYOUT PLAN	STA 121+00 TO STA 125+00		TRAIN CONTROL	CABLE / CONDUIT SCHEDULE
398 Y214 OCS BRIDGE GROUNDING LAYOUT PLAN	STA 125+00 TO STA 129+00	433 1013	TRAIN CONTROL	RIGHT OF WAY PLANS
399 Y215 OCS BRIDGE GROUNDING LAYOUT PLAN	STA 129+00 TO STA 133+00	460 DW001	RIGHT OF WAY KEY MAP	NIGHT OF WAT FEARS
	2ND STREET TO WMF		RIGHT OF WAY PLAN	100 GRAND BLVD
AND I VOICE I DOS LAVOUT DEAN	ZND STREET TO VMF		RIGHT OF WAY PLAN	101 GRAND BLVD
	ENLARCED VIEW	1 1 162 DW102	NIONI OF WAI FLAN	
	ENLARGED VIEW		DICHT OF WAY DIAN	
401 Y217 OCS LAYOUT PLAN	ENLARGED VIEW COMMIUNICATION SCHEDULES	463 RW103	RIGHT OF WAY PLAN	599 E RIVERFRONT ROAD - SHEET 1
401 Y217 OCS LAYOUT PLAN	COMMIUNICATION SCHEDULES	463 RW103 464 RW104	RIGHT OF WAY PLAN	599 E RIVERFRONT ROAD - SHEET 1 599 E RIVERFRONT ROAD - SHEET 2
401 Y217 OCS LAYOUT PLAN 402 Z001 COMMUNICATION SCHEDULE	COMMIUNICATION SCHEDULES COMMIUNICATION PLANS	463 RW103 464 RW104 465 RW105	RIGHT OF WAY PLAN RIGHT OF WAY PLAN	599 E RIVERFRONT ROAD - SHEET 1 599 E RIVERFRONT ROAD - SHEET 2 599 E RIVERFRONT ROAD - SHEET 3
401 Y217 OCS LAYOUT PLAN 402 Z001 COMMUNICATION SCHEDULE 403 Z101 COMMUNICATIONS PLAN	COMMIUNICATION SCHEDULES COMMIUNICATION PLANS NB STA BEGIN TO STA 113+00	463 RW103 464 RW104 465 RW105	RIGHT OF WAY PLAN	599 E RIVERFRONT ROAD - SHEET 1 599 E RIVERFRONT ROAD - SHEET 2 599 E RIVERFRONT ROAD - SHEET 3 599 E RIVERFRONT ROAD - SHEET 4
401 Y217 OCS LAYOUT PLAN 402 Z001 COMMUNICATION SCHEDULE 403 Z101 COMMUNICATIONS PLAN 404 Z102 COMMUNICATIONS PLAN	COMMIUNICATION SCHEDULES COMMIUNICATION PLANS NB STA BEGIN TO STA 113+00 NB STA 113+00 TO STA 117+00	463 RW103 464 RW104 465 RW105 466 RW106	RIGHT OF WAY PLAN RIGHT OF WAY PLAN RIGHT OF WAY PLAN	599 E RIVERFRONT ROAD - SHEET 1 599 E RIVERFRONT ROAD - SHEET 2 599 E RIVERFRONT ROAD - SHEET 3
401 Y217 OCS LAYOUT PLAN 402 Z001 COMMUNICATION SCHEDULE 403 Z101 COMMUNICATIONS PLAN 404 Z102 COMMUNICATIONS PLAN 405 Z103 COMMUNICATIONS PLAN	COMMIUNICATION SCHEDULES COMMIUNICATION PLANS NB STA BEGIN TO STA 113+00 NB STA 113+00 TO STA 117+00 NB STA 117+00 TO STA 121+00	463 RW103 464 RW104 465 RW105 466 RW106	RIGHT OF WAY PLAN RIGHT OF WAY PLAN	599 E RIVERFRONT ROAD - SHEET 1 599 E RIVERFRONT ROAD - SHEET 2 599 E RIVERFRONT ROAD - SHEET 3 599 E RIVERFRONT ROAD - SHEET 4 DETOUR PLAN
401 Y217 OCS LAYOUT PLAN 402 Z001 COMMUNICATION SCHEDULE 403 Z101 COMMUNICATIONS PLAN 404 Z102 COMMUNICATIONS PLAN 405 Z103 COMMUNICATIONS PLAN 406 Z104 COMMUNICATIONS PLAN	COMMIUNICATION SCHEDULES COMMIUNICATION PLANS NB STA BEGIN TO STA 113+00 NB STA 113+00 TO STA 117+00 NB STA 117+00 TO STA 121+00 NB STA 121+00 TO STA 125+00	463 RW103 464 RW104 465 RW105 466 RW106	RIGHT OF WAY PLAN RIGHT OF WAY PLAN RIGHT OF WAY PLAN DETOUR PLAN	599 E RIVERFRONT ROAD - SHEET 1 599 E RIVERFRONT ROAD - SHEET 2 599 E RIVERFRONT ROAD - SHEET 3 599 E RIVERFRONT ROAD - SHEET 4 DETOUR PLAN MILL AND OVERLAY PLANS
401 Y217 OCS LAYOUT PLAN 402 Z001 COMMUNICATION SCHEDULE 403 Z101 COMMUNICATIONS PLAN 404 Z102 COMMUNICATIONS PLAN 405 Z103 COMMUNICATIONS PLAN 405 Z103 COMMUNICATIONS PLAN 406 Z104 COMMUNICATIONS PLAN 407 Z105 COMMUNICATIONS PLAN	COMMIUNICATION SCHEDULES COMMIUNICATION PLANS NB STA BEGIN TO STA 113+00 NB STA 113+00 TO STA 117+00 NB STA 117+00 TO STA 121+00 NB STA 121+00 TO STA 125+00 NB STA 125+00 TO STA 125+00	463 RW103 464 RW104 465 RW105 466 RW106 467 DT101 468 R101	RIGHT OF WAY PLAN RIGHT OF WAY PLAN RIGHT OF WAY PLAN DETOUR PLAN ROADWAY MILL AND OVERLAY PLAN AND PROFILE	599 E RIVERFRONT ROAD - SHEET 1 599 E RIVERFRONT ROAD - SHEET 2 599 E RIVERFRONT ROAD - SHEET 3 599 E RIVERFRONT ROAD - SHEET 4 DETOUR PLAN MILL AND OVERLAY PLANS STA 0+00 TO STA 4+00
401 Y217 OCS LAYOUT PLAN 402 Z001 COMMUNICATION SCHEDULE 403 Z101 COMMUNICATIONS PLAN 404 Z102 COMMUNICATIONS PLAN 405 Z103 COMMUNICATIONS PLAN 406 Z104 COMMUNICATIONS PLAN 407 Z105 COMMUNICATIONS PLAN 408 Z106 COMMUNICATIONS PLAN	COMMIUNICATION SCHEDULES COMMIUNICATION PLANS NB STA BEGIN TO STA 113+00 NB STA 113+00 TO STA 117+00 NB STA 117+00 TO STA 121+00 NB STA 121+00 TO STA 122+00 NB STA 125+00 TO STA 129+00 NB STA 125+00 TO STA 133+00	463 RW103 464 RW104 465 RW105 466 RW106 467 DT101 468 R101 469 R102	RIGHT OF WAY PLAN RIGHT OF WAY PLAN RIGHT OF WAY PLAN DETOUR PLAN ROADWAY MILL AND OVERLAY PLAN AND PROFILE ROADWAY MILL AND OVERLAY PLAN AND PROFILE	599 E RIVERFRONT ROAD - SHEET 1 599 E RIVERFRONT ROAD - SHEET 2 599 E RIVERFRONT ROAD - SHEET 3 599 E RIVERFRONT ROAD - SHEET 4 DETOUR PLAN MILL AND OVERLAY PLANS STA 0+00 TO STA 4+00 STA 4+00 TO STA 8+00
401 Y217 OCS LAYOUT PLAN 402 Z001 COMMUNICATION SCHEDULE 403 Z101 COMMUNICATIONS PLAN 404 Z102 COMMUNICATIONS PLAN 405 Z103 COMMUNICATIONS PLAN 406 Z104 COMMUNICATIONS PLAN 407 Z105 COMMUNICATIONS PLAN 408 Z106 COMMUNICATIONS PLAN 409 Z107 COMMUNICATIONS PLAN	COMMIUNICATION SCHEDULES COMMIUNICATION PLANS NB STA BEGIN TO STA 113+00 NB STA 113+00 TO STA 117+00 NB STA 113+00 TO STA 121+00 NB STA 1121+00 TO STA 121+00 NB STA 121+00 TO STA 125+00 NB STA 125+00 TO STA 125+00 NB STA 129+00 TO STA 135+00 NB STA 133+00 TO STA 135+50	463 RW103 464 RW104 465 RW105 466 RW106 467 DT101 468 R101 469 R102 470 R103	RIGHT OF WAY PLAN RIGHT OF WAY PLAN RIGHT OF WAY PLAN DETOUR PLAN ROADWAY MILL AND OVERLAY PLAN AND PROFILE ROADWAY MILL AND OVERLAY PLAN AND PROFILE ROADWAY MILL AND OVERLAY PLAN AND PROFILE	599 E RIVERFRONT ROAD - SHEET 1
401 Y217 OCS LAYOUT PLAN 402 Z001 COMMUNICATION SCHEDULE 403 Z101 COMMUNICATIONS PLAN 404 Z102 COMMUNICATIONS PLAN 405 Z103 COMMUNICATIONS PLAN 406 Z104 COMMUNICATIONS PLAN 407 Z105 COMMUNICATIONS PLAN 408 Z106 COMMUNICATIONS PLAN 408 Z106 COMMUNICATIONS PLAN 409 Z107 COMMUNICATIONS PLAN 410 Z108 COMMUNICATIONS PLAN	COMMIUNICATION SCHEDULES COMMIUNICATION PLANS NB STA BEGIN TO STA 113+00 NB STA 113+00 TO STA 117+00 NB STA 117+00 TO STA 121+00 NB STA 121+00 TO STA 125+00 NB STA 121+00 TO STA 125+00 NB STA 125+00 TO STA 125+00 NB STA 129+00 TO STA 133+00 NB STA 133+00 TO STA 135+50 NB STA 135+50 TO STA 135+50	463 RW103 464 RW104 465 RW105 466 RW106 467 DT101 468 R101 469 R102 470 R103 471 R104	RIGHT OF WAY PLAN RIGHT OF WAY PLAN RIGHT OF WAY PLAN DETOUR PLAN ROADWAY MILL AND OVERLAY PLAN AND PROFILE	S99 E RIVERFRONT ROAD - SHEET 1
401 Y217 OCS LAYOUT PLAN 402 Z001 COMMUNICATION SCHEDULE 403 Z101 COMMUNICATIONS PLAN 404 Z102 COMMUNICATIONS PLAN 405 Z103 COMMUNICATIONS PLAN 406 Z104 COMMUNICATIONS PLAN 407 Z105 COMMUNICATIONS PLAN 408 Z106 COMMUNICATIONS PLAN 409 Z107 COMMUNICATIONS PLAN 409 Z107 COMMUNICATIONS PLAN 410 Z108 COMMUNICATIONS PLAN 411 Z109 COMMUNICATIONS PLAN	COMMIUNICATION SCHEDULES COMMIUNICATION PLANS NB STA BEGIN TO STA 113+00 NB STA 113+00 TO STA 117+00 NB STA 117+00 TO STA 121+00 NB STA 121+00 TO STA 125+00 NB STA 125+00 TO STA 125+00 NB STA 125+00 TO STA 133+00 NB STA 129+00 TO STA 133+00 NB STA 135+50 TO STA 139+50 NB STA 135+50 TO STA 139+50 NB STA 135+50 TO STA 143+50	463 RW103 464 RW104 465 RW105 466 RW106 467 DT101 468 R101 469 R102 470 R103 471 R104 472 R105	RIGHT OF WAY PLAN RIGHT OF WAY PLAN RIGHT OF WAY PLAN DETOUR PLAN ROADWAY MILL AND OVERLAY PLAN AND PROFILE	599 E RIVERFRONT ROAD - SHEET 1
401 Y217 OCS LAYOUT PLAN 402 Z001 COMMUNICATION SCHEDULE 403 Z101 COMMUNICATIONS PLAN 404 Z102 COMMUNICATIONS PLAN 405 Z103 COMMUNICATIONS PLAN 406 Z104 COMMUNICATIONS PLAN 407 Z105 COMMUNICATIONS PLAN 408 Z106 COMMUNICATIONS PLAN 409 Z107 COMMUNICATIONS PLAN 409 Z107 COMMUNICATIONS PLAN 410 Z108 COMMUNICATIONS PLAN 411 Z109 COMMUNICATIONS PLAN 411 Z109 COMMUNICATIONS PLAN 412 Z110 COMMUNICATIONS PLAN	COMMIUNICATION SCHEDULES COMMIUNICATION PLANS NB STA BEGIN TO STA 113+00 NB STA 113+00 TO STA 117+00 NB STA 117+00 TO STA 121+00 NB STA 121+00 TO STA 125+00 NB STA 122+00 TO STA 125+00 NB STA 125+00 TO STA 129+00 NB STA 129+00 TO STA 133+00 NB STA 133+00 TO STA 133+50 NB STA 135+50 TO STA 139+50 NB STA 139+50 TO STA 143+50 NB STA 139+50 TO STA 143+50	463 RW103 464 RW104 465 RW105 466 RW106 467 DT101 468 R101 469 R102 470 R103 471 R104	RIGHT OF WAY PLAN RIGHT OF WAY PLAN RIGHT OF WAY PLAN DETOUR PLAN ROADWAY MILL AND OVERLAY PLAN AND PROFILE	599 E RIVERFRONT ROAD - SHEET 1 599 E RIVERFRONT ROAD - SHEET 2 599 E RIVERFRONT ROAD - SHEET 3 599 E RIVERFRONT ROAD - SHEET 3 599 E RIVERFRONT ROAD - SHEET 4 DETOUR PLAN MILL AND OVERLAY PLANS STA 0+00 TO STA 4+00 STA 4+00 TO STA 8+00 STA 19+00 TO STA 23+00 STA 23+00 TO STA 23+00 2ND STREET TO VMF ALIGNMENT TABLE GRAND BOULEVARD & BERKLEY PARKWAY
401 Y217 OCS LAYOUT PLAN 402 Z001 COMMUNICATION SCHEDULE 403 Z101 COMMUNICATIONS PLAN 404 Z102 COMMUNICATIONS PLAN 405 Z103 COMMUNICATIONS PLAN 406 Z104 COMMUNICATIONS PLAN 407 Z105 COMMUNICATIONS PLAN 408 Z106 COMMUNICATIONS PLAN 409 Z107 COMMUNICATIONS PLAN 410 Z108 COMMUNICATIONS PLAN 410 Z108 COMMUNICATIONS PLAN 411 Z109 COMMUNICATIONS PLAN 412 Z110 COMMUNICATIONS PLAN 413 Z111 COMMUNICATIONS PLAN	COMMIUNICATION SCHEDULES COMMIUNICATION PLANS NB STA BEGIN TO STA 113+00 NB STA 113+00 TO STA 117+00 NB STA 117+00 TO STA 117+00 NB STA 117+00 TO STA 121+00 NB STA 121+00 TO STA 125+00 NB STA 121+00 TO STA 125+00 NB STA 129+00 TO STA 129+00 NB STA 129+00 TO STA 135+50 NB STA 135+50 TO STA 135+50 NB STA 135+50 TO STA 135+50 NB STA 139+50 TO STA 147+50 NB STA 139+50 TO STA 147+50 NB STA 147+50 TO END	463 RW103 464 RW104 465 RW106 466 RW106 467 DT101 468 R101 469 R102 470 R103 471 R104 472 R105 473 R201	RIGHT OF WAY PLAN RIGHT OF WAY PLAN RIGHT OF WAY PLAN RIGHT OF WAY PLAN DETOUR PLAN ROADWAY MILL AND OVERLAY PLAN AND PROFILE ROADWAY MILL AND OVERLAY	599 E RIVERFRONT ROAD - SHEET 1 599 E RIVERFRONT ROAD - SHEET 2 599 E RIVERFRONT ROAD - SHEET 3 599 E RIVERFRONT ROAD - SHEET 3 599 E RIVERFRONT ROAD - SHEET 4 DETOUR PLAN MILL AND OVERLAY PLANS STA 0+00 TO STA 4+00 STA 4+00 TO STA 8+00 STA 4+00 TO STA 23+00 STA 23+00 TO STA 23+00 STA 23+00 TO STA 28+00 2ND STREET TO VMF ALIGNMENT TABLE GRAND BOULEVARD & BERKLEY PARKWAY ILL AND OVERLAY CROSS SECTIONS
401 Y217 OCS LAYOUT PLAN 402 Z001 COMMUNICATION SCHEDULE 403 Z101 COMMUNICATIONS PLAN 404 Z102 COMMUNICATIONS PLAN 405 Z103 COMMUNICATIONS PLAN 406 Z104 COMMUNICATIONS PLAN 407 Z105 COMMUNICATIONS PLAN 408 Z106 COMMUNICATIONS PLAN 409 Z107 COMMUNICATIONS PLAN 409 Z107 COMMUNICATIONS PLAN 410 Z108 COMMUNICATIONS PLAN 411 Z109 COMMUNICATIONS PLAN 412 Z110 COMMUNICATIONS PLAN 413 Z111 COMMUNICATIONS PLAN	COMMIUNICATION SCHEDULES COMMIUNICATION PLANS NB STA BEGIN TO STA 113+00 NB STA 113+00 TO STA 117+00 NB STA 117+00 TO STA 121+00 NB STA 121+00 TO STA 125+00 NB STA 125+00 TO STA 125+00 NB STA 125+00 TO STA 133+00 NB STA 129+00 TO STA 135+50 NB STA 135+50 TO STA 135+50 NB STA 135+50 TO STA 135+50 NB STA 139+50 TO STA 135+50 NB STA 139+50 TO STA 143+50 NB STA 135+50 TO STA 143+50 NB STA 135+50 TO STA 147+50 NB STA 135+50 TO STA 147+50 NB STA 147+50 TO END 2ND STREET TO VMF	463 RW103 464 RW104 465 RW105 466 RW106 467 DT101 468 R101 469 R102 470 R103 471 R104 472 R105 473 R201	RIGHT OF WAY PLAN RIGHT OF WAY PLAN RIGHT OF WAY PLAN DETOUR PLAN ROADWAY MILL AND OVERLAY PLAN AND PROFILE	599 E RIVERFRONT ROAD - SHEET 1 599 E RIVERFRONT ROAD - SHEET 2 599 E RIVERFRONT ROAD - SHEET 3 599 E RIVERFRONT ROAD - SHEET 4 DETOUR PLAN MILL AND OVERLAY PLANS STA 0+00 TO STA 4+00 STA 4+00 TO STA 8+00 STA 19+00 TO STA 23+00 STA 23+00 TO STA 23+00 STA 23+00 TO STA 28+00 2ND STREET TO VMF ALIGNMENT TABLE GRAND BOULEVARD & BERKLEY PARKWAY ILL AND OVERLAY CROSS SECTIONS GRAND BOULEVARD
401 Y217 OCS LAYOUT PLAN 402 Z001 COMMUNICATION SCHEDULE 403 Z101 COMMUNICATIONS PLAN 404 Z102 COMMUNICATIONS PLAN 405 Z103 COMMUNICATIONS PLAN 406 Z104 COMMUNICATIONS PLAN 407 Z105 COMMUNICATIONS PLAN 408 Z106 COMMUNICATIONS PLAN 409 Z107 COMMUNICATIONS PLAN 410 Z108 COMMUNICATIONS PLAN 411 Z109 COMMUNICATIONS PLAN 412 Z110 COMMUNICATIONS PLAN 413 Z111 COMMUNICATIONS PLAN 414 Z112 COMMUNICATIONS PLAN	COMMIUNICATION SCHEDULES COMMIUNICATION PLANS NB STA BEGIN TO STA 113+00 NB STA 113+00 TO STA 117+00 NB STA 117+00 TO STA 121+00 NB STA 121+00 TO STA 125+00 NB STA 122+00 TO STA 125+00 NB STA 125+00 TO STA 129+00 NB STA 129+00 TO STA 133+00 NB STA 133+00 TO STA 133+00 NB STA 135+50 TO STA 139+50 NB STA 135+50 TO STA 139+50 NB STA 139+50 TO STA 143+50 NB STA 139+50 TO STA 143+50 NB STA 134-50 TO STA 147+50 NB STA 147+50 TO END 2ND STREET TO VMF COMMIUNICATION DETAILS	463 RW103 464 RW104 465 RW105 466 RW106 467 DT101 468 R101 469 R102 470 R103 471 R104 472 R105 473 R201 474 XS01 475 XS02	RIGHT OF WAY PLAN RIGHT OF WAY PLAN RIGHT OF WAY PLAN RIGHT OF WAY PLAN DETOUR PLAN ROADWAY MILL AND OVERLAY PLAN AND PROFILE ROADWAY MILL AND OVERLAY CROSS SECTIONS ROADWAY MILL AND OVERLAY CROSS SECTIONS	599 E RIVERFRONT ROAD - SHEET 1 599 E RIVERFRONT ROAD - SHEET 2 599 E RIVERFRONT ROAD - SHEET 3 599 E RIVERFRONT ROAD - SHEET 3 599 E RIVERFRONT ROAD - SHEET 4 DETOUR PLAN MILL AND OVERLAY PLANS STA 0+00 TO STA 4+00 STA 4+00 TO STA 8+00 STA 4+00 TO STA 23+00 STA 23+00 TO STA 23+00 STA 23+00 TO STA 28+00 2ND STREET TO VMF ALIGNMENT TABLE GRAND BOULEVARD & BERKLEY PARKWAY ILL AND OVERLAY CROSS SECTIONS
401 Y217 OCS LAYOUT PLAN 402 Z001 COMMUNICATION SCHEDULE 403 Z101 COMMUNICATIONS PLAN 404 Z102 COMMUNICATIONS PLAN 405 Z103 COMMUNICATIONS PLAN 406 Z104 COMMUNICATIONS PLAN 407 Z105 COMMUNICATIONS PLAN 408 Z106 COMMUNICATIONS PLAN 409 Z107 COMMUNICATIONS PLAN 409 Z107 COMMUNICATIONS PLAN 410 Z108 COMMUNICATIONS PLAN 411 Z109 COMMUNICATIONS PLAN 412 Z110 COMMUNICATIONS PLAN 413 Z111 COMMUNICATIONS PLAN 414 Z112 COMMUNICATIONS PLAN	COMMIUNICATION SCHEDULES COMMIUNICATION PLANS NB STA BEGIN TO STA 113+00 NB STA 113+00 TO STA 117+00 NB STA 117+00 TO STA 117+00 NB STA 117+00 TO STA 121+00 NB STA 121+00 TO STA 125+00 NB STA 121+00 TO STA 125+00 NB STA 125+00 TO STA 125+00 NB STA 129+00 TO STA 135+50 NB STA 133+00 TO STA 135+50 NB STA 135+50 TO STA 135+50 NB STA 135+50 TO STA 135+50 NB STA 134-50 TO STA 147+50 NB STA 147+50 TO END 2ND STREET TO VMF COMMIUNICATION DETAILS TYPICAL MANHOLE DETAILS	463 RW103 464 RW104 465 RW106 466 RW106 467 DT101 468 R101 468 R101 469 R102 470 R103 471 R104 472 R105 473 R201 474 XS01 475 XS02 476 XS03	RIGHT OF WAY PLAN RIGHT OF WAY PLAN RIGHT OF WAY PLAN RIGHT OF WAY PLAN DETOUR PLAN ROADWAY MILL AND OVERLAY PLAN AND PROFILE ROADWAY MILL AND OVERLAY CROSS SECTIONS	599 E RIVERFRONT ROAD - SHEET 1 599 E RIVERFRONT ROAD - SHEET 2 599 E RIVERFRONT ROAD - SHEET 3 599 E RIVERFRONT ROAD - SHEET 3 599 E RIVERFRONT ROAD - SHEET 4 DETOUR PLAN MILL AND OVERLAY PLANS STA 0+00 TO STA 4+00 STA 4+00 TO STA 8+00 STA 4+00 TO STA 23+00 STA 23+00 TO STA 23+00 2ND STREET TO VMF ALIGNMENT TABLE GRAND BOULEVARD & BERKLEY PARKWAY ILL AND OVERLAY CROSS SECTIONS GRAND BOULEVARD GRAND BOULEVARD GRAND BOULEVARD
401 Y217 OCS LAYOUT PLAN 402 Z001 COMMUNICATION SCHEDULE 403 Z101 COMMUNICATIONS PLAN 404 Z102 COMMUNICATIONS PLAN 405 Z103 COMMUNICATIONS PLAN 406 Z104 COMMUNICATIONS PLAN 407 Z105 COMMUNICATIONS PLAN 408 Z106 COMMUNICATIONS PLAN 409 Z107 COMMUNICATIONS PLAN 409 Z107 COMMUNICATIONS PLAN 410 Z108 COMMUNICATIONS PLAN 411 Z109 COMMUNICATIONS PLAN 412 Z110 COMMUNICATIONS PLAN 413 Z111 COMMUNICATIONS PLAN 414 Z112 COMMUNICATIONS PLAN 415 Z601 SYSTEMWIDE ELECTRICAL	COMMIUNICATION SCHEDULES COMMIUNICATION PLANS NB STA BEGIN TO STA 113+00 NB STA 113+00 TO STA 117+00 NB STA 117+00 TO STA 121+00 NB STA 117+00 TO STA 121+00 NB STA 121+00 TO STA 125+00 NB STA 125+00 TO STA 125+00 NB STA 125+00 TO STA 133+00 NB STA 129+00 TO STA 133+00 NB STA 133+50 TO STA 135+50 NB STA 135+50 TO STA 139+50 NB STA 135+50 TO STA 139+50 NB STA 143+50 TO STA 143+50 NB STA 143+50 TO STA 143+50 NB STA 147+50 TO END 2ND STREET TO VMF COMMIUNICATION DETAILS TYPICAL MANHOLE DETAILS MANHOLE INSTALLATION AND SWITCH HEATER/TRACK CIRCUIT BLOCKOUT DETAILS	463 RW103 464 RW104 465 RW105 466 RW106 467 DT101 468 R101 469 R102 470 R103 471 R104 472 R105 473 R201 474 XS01 475 XS02 476 XS03 477 XS04	RIGHT OF WAY PLAN RIGHT OF WAY PLAN RIGHT OF WAY PLAN RIGHT OF WAY PLAN DETOUR PLAN ROADWAY MILL AND OVERLAY PLAN AND PROFILE ROADWAY MILL AND OVERLAY CROSS SECTIONS	599 E RIVERFRONT ROAD - SHEET 1 599 E RIVERFRONT ROAD - SHEET 2 599 E RIVERFRONT ROAD - SHEET 3 599 E RIVERFRONT ROAD - SHEET 4 DETOUR PLAN MILL AND OVERLAY PLANS STA 0+00 TO STA 4+00 STA 4+00 TO STA 8+00 STA 4+00 TO STA 23+00 STA 23+00 TO STA 23+00 STA 23+00 TO STA 23+00 STA 23+00 TO STA 28+00 ZND STREET TO VMF ALIGNMENT TABLE GRAND BOULEVARD & BERKLEY PARKWAY ILL AND OVERLAY CROSS SECTIONS GRAND BOULEVARD GRAND BOULEVARD GRAND BOULEVARD GRAND BOULEVARD GRAND BOULEVARD
401 Y217 OCS LAYOUT PLAN 402 Z001 COMMUNICATION SCHEDULE 403 Z101 COMMUNICATIONS PLAN 404 Z102 COMMUNICATIONS PLAN 405 Z103 COMMUNICATIONS PLAN 406 Z104 COMMUNICATIONS PLAN 407 Z105 COMMUNICATIONS PLAN 408 Z106 COMMUNICATIONS PLAN 409 Z107 COMMUNICATIONS PLAN 409 Z107 COMMUNICATIONS PLAN 410 Z108 COMMUNICATIONS PLAN 411 Z109 COMMUNICATIONS PLAN 412 Z110 COMMUNICATIONS PLAN 413 Z111 COMMUNICATIONS PLAN 414 Z112 COMMUNICATIONS PLAN 415 Z601 SYSTEMWIDE ELECTRICAL 416 Z602 SYSTEMWIDE ELECTRICAL 417 Z603 SYSTEMWIDE ELECTRICAL	COMMIUNICATION SCHEDULES COMMIUNICATION PLANS NB STA BEGIN TO STA 113+00 NB STA 113+00 TO STA 117+00 NB STA 113+00 TO STA 121+00 NB STA 121+00 TO STA 125+00 NB STA 121+00 TO STA 125+00 NB STA 125+00 TO STA 135+50 NB STA 129+00 TO STA 135+50 NB STA 135+50 TO STA 135+50 NB STA 135+50 TO STA 139+50 NB STA 139+50 TO STA 139+50 NB STA 139+50 TO STA 143+50 NB STA 143+50 TO STA 143+50 NB STA 147+50 TO END 2ND STREET TO VMF COMMIUNICATION DETAILS TYPICAL MANHOLE DETAILS MANHOLE INSTALLATION AND SWITCH HEATER/TRACK CIRCUIT BLOCKOUT DETAILS FIBER OPTIC SPLICE VAULT	463 RW103 464 RW104 465 RW105 466 RW106 467 DT101 468 R101 469 R102 470 R103 471 R104 472 R105 473 R201 474 XS01 475 XS02 476 XS03 477 XS04 478 XS05	RIGHT OF WAY PLAN RIGHT OF WAY PLAN RIGHT OF WAY PLAN RIGHT OF WAY PLAN DETOUR PLAN ROADWAY MILL AND OVERLAY PLAN AND PROFILE ROADWAY MILL AND OVERLAY CROSS SECTIONS	599 E RIVERFRONT ROAD - SHEET 1 599 E RIVERFRONT ROAD - SHEET 2 599 E RIVERFRONT ROAD - SHEET 3 599 E RIVERFRONT ROAD - SHEET 3 599 E RIVERFRONT ROAD - SHEET 4 DETOUR PLAN MILL AND OVERLAY PLANS STA 0+00 TO STA 4+00 STA 4+00 TO STA 8+00 STA 19+00 TO STA 23+00 STA 23+00 TO STA 23+00 STA 23+00 TO STA 23+00 STA 23+00 TO STA 28+00 2ND STREET TO VMF ALIGNMENT TABLE GRAND BOULEVARD & BERKLEY PARKWAY ILL AND OVERLAY CROSS SECTIONS GRAND BOULEVARD
401 Y217 OCS LAYOUT PLAN 402 Z001 COMMUNICATION SCHEDULE 403 Z101 COMMUNICATIONS PLAN 404 Z102 COMMUNICATIONS PLAN 405 Z103 COMMUNICATIONS PLAN 406 Z104 COMMUNICATIONS PLAN 407 Z105 COMMUNICATIONS PLAN 408 Z106 COMMUNICATIONS PLAN 409 Z107 COMMUNICATIONS PLAN 409 Z107 COMMUNICATIONS PLAN 410 Z108 COMMUNICATIONS PLAN 411 Z109 COMMUNICATIONS PLAN 412 Z110 COMMUNICATIONS PLAN 413 Z111 COMMUNICATIONS PLAN 414 Z112 COMMUNICATIONS PLAN 415 Z601 SYSTEMWIDE ELECTRICAL 416 Z602 SYSTEMWIDE ELECTRICAL 417 Z603 SYSTEMWIDE ELECTRICAL	COMMIUNICATION PLANS NB STA BEGIN TO STA 113+00 NB STA 113+00 TO STA 117+00 NB STA 117+00 TO STA 117+00 NB STA 117+00 TO STA 121+00 NB STA 121+00 TO STA 125+00 NB STA 121+00 TO STA 125+00 NB STA 125+00 TO STA 125+00 NB STA 129+00 TO STA 135+50 NB STA 133+00 TO STA 135+50 NB STA 135+50 TO STA 135+50 NB STA 135+50 TO STA 135+50 NB STA 134-50 TO STA 143+50 NB STA 134-50 TO STA 147+50 NB STA 147+50 TO END 2ND STREET TO VMF COMMIUNICATION DETAILS TYPICAL MANHOLE DETAILS MANHOLE INSTALLATION AND SWITCH HEATER/TRACK CIRCUIT BLOCKOUT DETAILS FIBER OPTIC SPLICE VAULT HANDHOLE DETAILS	463 RW103 464 RW104 465 RW105 466 RW106 467 DT101 468 R101 469 R102 470 R103 471 R104 472 R105 473 R201 474 XS01 475 XS02 476 XS03 477 XS04 478 XS05 478 XS05 479 XS06	RIGHT OF WAY PLAN RIGHT OF WAY PLAN RIGHT OF WAY PLAN RIGHT OF WAY PLAN DETOUR PLAN ROADWAY MILL AND OVERLAY PLAN AND PROFILE ROADWAY MILL AND OVERLAY CROSS SECTIONS	599 E RIVERFRONT ROAD - SHEET 1 599 E RIVERFRONT ROAD - SHEET 2 599 E RIVERFRONT ROAD - SHEET 3 599 E RIVERFRONT ROAD - SHEET 3 599 E RIVERFRONT ROAD - SHEET 4 DETOUR PLAN MILL AND OVERLAY PLANS STA 0+00 TO STA 0+00
401 Y217 OCS LAYOUT PLAN 402 Z001 COMMUNICATION SCHEDULE 403 Z101 COMMUNICATIONS PLAN 404 Z102 COMMUNICATIONS PLAN 405 Z103 COMMUNICATIONS PLAN 406 Z104 COMMUNICATIONS PLAN 407 Z105 COMMUNICATIONS PLAN 408 Z106 COMMUNICATIONS PLAN 409 Z107 COMMUNICATIONS PLAN 409 Z107 COMMUNICATIONS PLAN 410 Z108 COMMUNICATIONS PLAN 411 Z109 COMMUNICATIONS PLAN 412 Z110 COMMUNICATIONS PLAN 413 Z111 COMMUNICATIONS PLAN 414 Z112 COMMUNICATIONS PLAN 415 Z601 SYSTEMWIDE ELECTRICAL 416 Z602 SYSTEMWIDE ELECTRICAL 417 Z603 SYSTEMWIDE ELECTRICAL 418 Z604 SYSTEMWIDE ELECTRICAL	COMMIUNICATION SCHEDULES COMMIUNICATION PLANS NB STA BEGIN TO STA 113+00 NB STA 113+00 TO STA 117+00 NB STA 117+00 TO STA 121+00 NB STA 117+00 TO STA 125+00 NB STA 121+00 TO STA 125+00 NB STA 125+00 TO STA 125+00 NB STA 125+00 TO STA 135+50 NB STA 129+00 TO STA 135+50 NB STA 135+50 TO STA 135+50 NB STA 135+50 TO STA 135+50 NB STA 135+50 TO STA 143+50 NB STA 143+50 TO STA 143+50 NB STA 143+50 TO STA 143+50 NB STA 147+50 TO END 2ND STREET TO VMF COMMIUNICATION DETAILS TYPICAL MANHOLE DETAILS MANHOLE INSTALLATION AND SWITCH HEATER/TRACK CIRCUIT BLOCKOUT DETAILS FIBER OPTIC SPLICE VAULT HANDHOLE DETAILS TYPICAL TRACK CIRCUIT BLOCKOUT DETAIL	463 RW103 464 RW104 465 RW105 466 RW106 467 DT101 468 R101 469 R102 470 R103 471 R104 472 R105 473 R201 474 XS01 475 XS02 476 XS03 477 XS04 478 XS05 480 XS07	RIGHT OF WAY PLAN RIGHT OF WAY PLAN RIGHT OF WAY PLAN RIGHT OF WAY PLAN DETOUR PLAN ROADWAY MILL AND OVERLAY PLAN AND PROFILE ROADWAY MILL AND OVERLAY CROSS SECTIONS	599 E RIVERFRONT ROAD - SHEET 1 599 E RIVERFRONT ROAD - SHEET 2 599 E RIVERFRONT ROAD - SHEET 3 599 E RIVERFRONT ROAD - SHEET 3 599 E RIVERFRONT ROAD - SHEET 4 DETOUR PLAN MILL AND OVERLAY PLANS STA 0+00 TO STA 4+00 STA 4+00 TO STA 8+00 STA 4+00 TO STA 23+00 STA 23+00 TO STA 23+00 STA 23+00 TO STA 28+00 2ND STREET TO VMF ALIGNMENT TABLE GRAND BOULEVARD & BERKLEY PARKWAY ILL AND OVERLAY CROSS SECTIONS GRAND BOULEVARD
401 Y217 OCS LAYOUT PLAN 402 Z001 COMMUNICATION SCHEDULE 403 Z101 COMMUNICATIONS PLAN 404 Z102 COMMUNICATIONS PLAN 405 Z103 COMMUNICATIONS PLAN 406 Z104 COMMUNICATIONS PLAN 407 Z105 COMMUNICATIONS PLAN 408 Z106 COMMUNICATIONS PLAN 409 Z107 COMMUNICATIONS PLAN 410 Z108 COMMUNICATIONS PLAN 411 Z109 COMMUNICATIONS PLAN 412 Z110 COMMUNICATIONS PLAN 413 Z111 COMMUNICATIONS PLAN 414 Z112 COMMUNICATIONS PLAN 415 Z601 SYSTEMWIDE ELECTRICAL 416 Z602 SYSTEMWIDE ELECTRICAL 417 Z603 SYSTEMWIDE ELECTRICAL 419 Z606 SYSTEMWIDE ELECTRICAL 419 Z606 SYSTEMWIDE ELECTRICAL 419 Z606 SYSTEMWIDE ELECTRICAL	COMMIUNICATION PLANS NB STA BEGIN TO STA 113+00 NB STA 113+00 TO STA 117+00 NB STA 117+00 TO STA 117+00 NB STA 117+00 TO STA 121+00 NB STA 121+00 TO STA 125+00 NB STA 125+00 TO STA 125+00 NB STA 125+00 TO STA 135+50 NB STA 135+50 TO STA 135+50 NB STA 135+50 TO STA 135+50 NB STA 135+50 TO STA 135+50 NB STA 137+50 TO STA 147+50 NB STA 137+50 TO STA 147+50 NB STA 147+50 TO END 2ND STREET TO VMF COMMIUNICATION DETAILS TYPICAL MANHOLE DETAILS MANHOLE INSTALLATION AND SWITCH HEATER/TRACK CIRCUIT BLOCKOUT DETAILS FIBER OPTIC SPLICE VAULT HANDHOLE DETAILS TYPICAL TRACK CIRCUIT BLOCKOUT DETAIL TRACK TURNOUT BLOCKOUT DETAIL TRACK TURNOUT BLOCKOUT DETAIL	463 RW103 464 RW104 465 RW105 466 RW106 467 DT101 468 R101 469 R102 470 R103 471 R104 472 R105 473 R201 474 XS01 475 XS02 476 XS03 477 XS04 478 XS05 479 XS06 479 XS06 479 XS06 479 XS07 481 XS08	RIGHT OF WAY PLAN RIGHT OF WAY PLAN RIGHT OF WAY PLAN RIGHT OF WAY PLAN DETOUR PLAN ROADWAY MILL AND OVERLAY PLAN AND PROFILE ROADWAY MILL AND OVERLAY CROSS SECTIONS	599 E RIVERFRONT ROAD - SHEET 1 599 E RIVERFRONT ROAD - SHEET 2 599 E RIVERFRONT ROAD - SHEET 3 599 E RIVERFRONT ROAD - SHEET 4 DETOUR PLAN MILL AND OVERLAY PLANS STA 0+00 TO STA 4+00 STA 4+00 TO STA 8+00 STA 19+00 TO STA 23+00 STA 23+00 TO STA 23+00 2ND STREET TO VMF ALIGNMENT TABLE GRAND BOULEVARD & BERKLEY PARKWAY ILL AND OVERLAY CROSS SECTIONS GRAND BOULEVARD
401 Y217 OCS LAYOUT PLAN 402 Z001 COMMUNICATION SCHEDULE 403 Z101 COMMUNICATIONS PLAN 404 Z102 COMMUNICATIONS PLAN 405 Z103 COMMUNICATIONS PLAN 406 Z104 COMMUNICATIONS PLAN 407 Z105 COMMUNICATIONS PLAN 408 Z106 COMMUNICATIONS PLAN 409 Z107 COMMUNICATIONS PLAN 409 Z107 COMMUNICATIONS PLAN 410 Z108 COMMUNICATIONS PLAN 411 Z109 COMMUNICATIONS PLAN 412 Z110 COMMUNICATIONS PLAN 413 Z111 COMMUNICATIONS PLAN 414 Z112 COMMUNICATIONS PLAN 415 Z601 SYSTEMWIDE ELECTRICAL 416 Z602 SYSTEMWIDE ELECTRICAL 417 Z603 SYSTEMWIDE ELECTRICAL 418 Z604 SYSTEMWIDE ELECTRICAL 419 Z606 SYSTEMWIDE ELECTRICAL 410 Z607 SYSTEMWIDE ELECTRICAL 411 Z608 SYSTEMWIDE ELECTRICAL	COMMIUNICATION PLANS NB STA BEGIN TO STA 113+00 NB STA 113+00 TO STA 117+00 NB STA 117+00 TO STA 117+00 NB STA 117+00 TO STA 121+00 NB STA 121+00 TO STA 125+00 NB STA 122+00 TO STA 125+00 NB STA 125+00 TO STA 125+00 NB STA 129+00 TO STA 135+50 NB STA 133+00 TO STA 135+50 NB STA 135+50 TO STA 135+50 NB STA 135+50 TO STA 135+50 NB STA 134-50 TO STA 143+50 NB STA 134-50 TO STA 147+50 NB STA 147+50 TO END 2ND STREET TO VMF COMMIUNICATION DETAILS TYPICAL MANHOLE DETAILS MANHOLE INSTALLATION AND SWITCH HEATER/TRACK CIRCUIT BLOCKOUT DETAILS FIBER OPTIC SPLICE VAULT HANDHOLE DETAILS TYPICAL TRACK CIRCUIT BLOCKOUT DETAIL TRACK TURNOUT BLOCKOUT DETAIL TYPICAL TRACK CIRCUIT BLOCKOUT DETAIL TYPICAL DUCTBANK INSTALLATION MANHOLE AND CONDUIT LABELING AND CONDUIT STUB-UP DETAIL	463 RW103 464 RW104 465 RW105 466 RW106 467 DT101 468 R101 469 R102 470 R103 471 R104 472 R105 473 R201 474 XS01 474 XS01 475 XS02 476 XS03 477 XS04 478 XS05 479 XS06 480 XS07 481 XS08	RIGHT OF WAY PLAN RIGHT OF WAY PLAN RIGHT OF WAY PLAN RIGHT OF WAY PLAN DETOUR PLAN ROADWAY MILL AND OVERLAY PLAN AND PROFILE ROADWAY MILL AND OVERLAY CROSS SECTIONS	599 E RIVERFRONT ROAD - SHEET 1 599 E RIVERFRONT ROAD - SHEET 2 599 E RIVERFRONT ROAD - SHEET 3 599 E RIVERFRONT ROAD - SHEET 3 599 E RIVERFRONT ROAD - SHEET 4 DETOUR PLAN MILL AND OVERLAY PLANS STA 0+00 TO STA 4+00 STA 4+00 TO STA 8+00 STA 4+00 TO STA 8+00 STA 23+00 TO STA 23+00 STA 23+00 TO STA 23+00 2ND STREET TO VMF ALIGNMENT TABLE GRAND BOULEVARD & BERKLEY PARKWAY ILL AND OVERLAY CROSS SECTIONS GRAND BOULEVARD BERKLEY PARKWAY BERKLEY PARKWAY
412 Z110 COMMUNICATIONS PLAN 413 Z111 COMMUNICATIONS PLAN 414 Z112 COMMUNICATIONS PLAN 415 Z601 SYSTEMWIDE ELECTRICAL 416 Z602 SYSTEMWIDE ELECTRICAL 417 Z603 SYSTEMWIDE ELECTRICAL 418 Z604 SYSTEMWIDE ELECTRICAL 419 Z606 SYSTEMWIDE ELECTRICAL 420 Z607 SYSTEMWIDE ELECTRICAL 421 Z608 SYSTEMWIDE ELECTRICAL 422 Z609 SYSTEMWIDE ELECTRICAL 422 Z609 SYSTEMWIDE ELECTRICAL 423 Z609 SYSTEMWIDE ELECTRICAL 424 Z609 SYSTEMWIDE ELECTRICAL 425 Z609 SYSTEMWIDE ELECTRICAL 426 Z609 SYSTEMWIDE ELECTRICAL 427 Z609 SYSTEMWIDE ELECTRICAL 428 Z609 SYSTEMWIDE ELECTRICAL 429 Z609 SYSTEMWIDE ELECTRICAL 420 Z609 SYSTEMWIDE ELECTRICAL 421 Z609 SYSTEMWIDE ELECTRICAL 422 Z609 SYSTEMWIDE ELECTRICAL 433 Z604 Z605 Z60	COMMIUNICATION PLANS NB STA BEGIN TO STA 113+00 NB STA 113+00 TO STA 117+00 NB STA 117+00 TO STA 117+00 NB STA 117+00 TO STA 121+00 NB STA 121+00 TO STA 125+00 NB STA 125+00 TO STA 125+00 NB STA 125+00 TO STA 133+00 NB STA 129+00 TO STA 135+50 NB STA 135+50 TO STA 135+50 NB STA 135+50 TO STA 135+50 NB STA 137-50 TO STA 135+50 NB STA 137-50 TO STA 147+50 NB STA 137-50 TO STA 147+50 NB STA 147+50 TO END 2ND STREET TO WF COMMIUNICATION DETAILS TYPICAL MANHOLE DETAILS MANHOLE INSTALLATION AND SWITCH HEATER/TRACK CIRCUIT BLOCKOUT DETAILS FIBER OPTIC SPLICE VAULT HANDHOLE DETAILS TYPICAL TRACK CIRCUIT BLOCKOUT DETAIL TRACK TURNOUT BLOCKOUT DETAIL TYPICAL TRACK CIRCUIT BLOCKOUT DETAIL TYPICAL DUCTBANK INSTALLATION MANHOLE AND CONDUIT LABELING AND CONDUIT STUB-UP DETAIL COMMUNICATION CONDUIT TYPICAL SECTIONS	463 RW103 464 RW104 465 RW105 466 RW106 467 DT101 468 R101 469 R102 470 R103 471 R104 472 R105 473 R201 474 XS01 474 XS01 475 XS02 476 XS03 477 XS04 478 XS05 479 XS06 480 XS07 481 XS08 483 XS10	RIGHT OF WAY PLAN RIGHT OF WAY PLAN RIGHT OF WAY PLAN RIGHT OF WAY PLAN DETOUR PLAN ROADWAY MILL AND OVERLAY PLAN AND PROFILE ROADWAY MILL AND OVERLAY CROSS SECTIONS	599 E RIVERFRONT ROAD - SHEET 1 599 E RIVERFRONT ROAD - SHEET 2 599 E RIVERFRONT ROAD - SHEET 3 599 E RIVERFRONT ROAD - SHEET 4 DETOUR PLAN MILL AND OVERLAY PLANS STA 0+00 TO STA 4+00 STA 4+00 TO STA 8+00 STA 4+00 TO STA 23+00 STA 23+00 TO STA 23+00 2ND STREET TO VMF ALIGNMENT TABLE GRAND BOULEVARD & BERKLEY PARKWAY ILL AND OVERLAY COSS SECTIONS GRAND BOULEVARD
401 Y217 OCS LAYOUT PLAN	COMMIUNICATION SCHEDULES COMMIUNICATION PLANS NB STA BEGIN TO STA 113+00 NB STA 113+00 TO STA 117+00 NB STA 113+00 TO STA 117+00 NB STA 117+00 TO STA 121+00 NB STA 121+00 TO STA 125+00 NB STA 125+00 TO STA 125+00 NB STA 125+00 TO STA 135+50 NB STA 135+50 TO STA 135+50 NB STA 135+50 TO STA 135+50 NB STA 135+50 TO STA 139+50 NB STA 139+50 TO STA 139+50 NB STA 137+50 TO STA 143+50 NB STA 147+50 TO END 2ND STREET TO VMF COMMIUNICATION DETAILS TYPICAL MANHOLE DETAILS MANHOLE INSTALLATION AND SWITCH HEATER/TRACK CIRCUIT BLOCKOUT DETAILS FIBER OPTIC SPLICE VAULT HANDHOHOLE DETAILS TYPICAL TRACK CIRCUIT BLOCKOUT DETAIL TRACK TURNOUT BLOCKOUT DETAIL TRACK TURNOUT BLOCKOUT DETAIL TYPICAL TRACK CIRCUIT BLOCKOUT DETAIL TRACK TURNOUT BLOCKOUT DETAIL TYPICAL TRACK CIRCUIT BLOCKOUT DETAIL TRACK TURNOUT BLOCKOUT DETAIL TYPICAL TRACK CIRCUIT BLOCKOUT DETAIL TRACK TURNOUT BLOCKOUT DETAIL TYPICAL TRACK CIRCUIT BLOCKOUT DETAIL TYPICAL TRACK SECTIONS	463 RW103 464 RW104 465 RW105 466 RW106 467 DT101 468 R101 469 R102 470 R103 471 R104 472 R105 473 R201 474 XS01 475 XS02 476 XS03 477 XS04 478 XS05 479 XS06 479 XS06 479 XS06 479 XS07 481 XS08 482 XS09 482 XS09 484 XS11	RIGHT OF WAY PLAN RIGHT OF WAY PLAN RIGHT OF WAY PLAN RIGHT OF WAY PLAN DETOUR PLAN ROADWAY MILL AND OVERLAY PLAN AND PROFILE ROADWAY MILL AND OVERLAY CROSS SECTIONS	S99 E RIVERFRONT ROAD - SHEET 1 S99 E RIVERFRONT ROAD - SHEET 2 S99 E RIVERFRONT ROAD - SHEET 3 S99 E RIVERFRONT ROAD - SHEET 4 DETOUR PLAN MILL AND OVERLAY PLANS STA 0+00 TO STA 4+00 STA 4+00 TO STA 8+00 STA 19+00 TO STA 23+00 STA 23+00 TO STA 23+00 2ND STREET TO VMF ALIGNMENT TABLE GRAND BOULEVARD & BERKLEY PARKWAY ILL AND OVERLAY CROSS SECTIONS GRAND BOULEVARD
401 Y217 OCS LAYOUT PLAN	COMMIUNICATION PLANS NB STA BEGIN TO STA 113+00 NB STA 113+00 TO STA 117+00 NB STA 117+00 TO STA 117+00 NB STA 117+00 TO STA 121+00 NB STA 121+00 TO STA 125+00 NB STA 125+00 TO STA 125+00 NB STA 125+00 TO STA 133+00 NB STA 129+00 TO STA 135+50 NB STA 135+50 TO STA 135+50 NB STA 135+50 TO STA 135+50 NB STA 137-50 TO STA 135+50 NB STA 137-50 TO STA 147+50 NB STA 137-50 TO STA 147+50 NB STA 147+50 TO END 2ND STREET TO WF COMMIUNICATION DETAILS TYPICAL MANHOLE DETAILS MANHOLE INSTALLATION AND SWITCH HEATER/TRACK CIRCUIT BLOCKOUT DETAILS FIBER OPTIC SPLICE VAULT HANDHOLE DETAILS TYPICAL TRACK CIRCUIT BLOCKOUT DETAIL TRACK TURNOUT BLOCKOUT DETAIL TYPICAL TRACK CIRCUIT BLOCKOUT DETAIL TYPICAL DUCTBANK INSTALLATION MANHOLE AND CONDUIT LABELING AND CONDUIT STUB-UP DETAIL COMMUNICATION CONDUIT TYPICAL SECTIONS	463 RW103 464 RW104 465 RW105 466 RW106 467 DT101 468 R101 469 R102 470 R103 471 R104 472 R105 473 R201 474 XS01 475 XS02 476 XS03 477 XS04 478 XS05 479 XS06 480 XS07 481 XS08 482 XS09 483 XS10 485 XS12	RIGHT OF WAY PLAN RIGHT OF WAY PLAN RIGHT OF WAY PLAN RIGHT OF WAY PLAN DETOUR PLAN ROADWAY MILL AND OVERLAY PLAN AND PROFILE ROADWAY MILL AND OVERLAY CROSS SECTIONS	599 E RIVERFRONT ROAD - SHEET 1 599 E RIVERFRONT ROAD - SHEET 2 599 E RIVERFRONT ROAD - SHEET 3 599 E RIVERFRONT ROAD - SHEET 4 DETOUR PLAN MILL AND OVERLAY PLANS STA 0+00 TO STA 4+00 STA 4+00 TO STA 8+00 STA 4+00 TO STA 23+00 STA 23+00 TO STA 23+00 2ND STREET TO VMF ALIGNMENT TABLE GRAND BOULEVARD & BERKLEY PARKWAY ILL AND OVERLAY COSS SECTIONS GRAND BOULEVARD

REV	DATE	DESCRIPTION	DESIGNED BY	ммо
			CHECKED BY	JWR
			DRAWN BY	ммо
			-	
			CHECKED BY	JWR
			APPROVED BY	NKS
PLOT DATE:	\$DATE\$	\$TIME\$	DATE	12-23-2022





This set of plans is not for These plans are intended to build interest in bidding 22 the project.


ISSUED FOR BID 10450 Holmes Road Suite 600 Kansas City, MO 64131-3471 816-360-2700 Certificate of Authority: 000856 NOT FOR CONSTRUCTION


SHEET 4

DRAWING NO.: SHEET NO.: G013 5

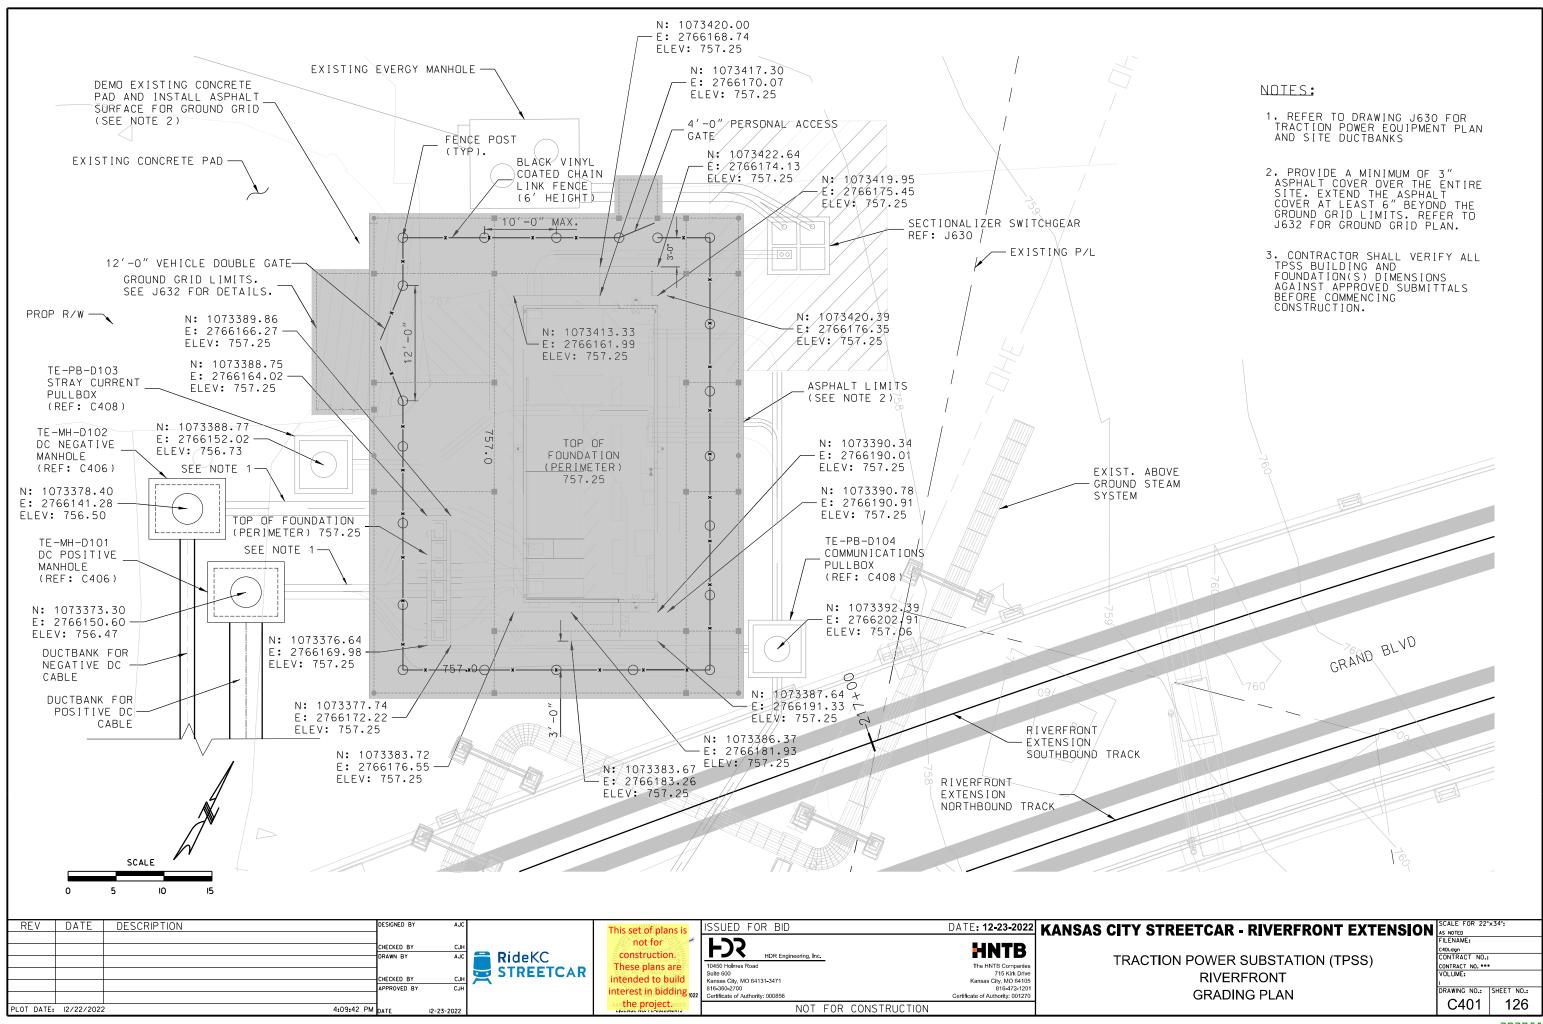

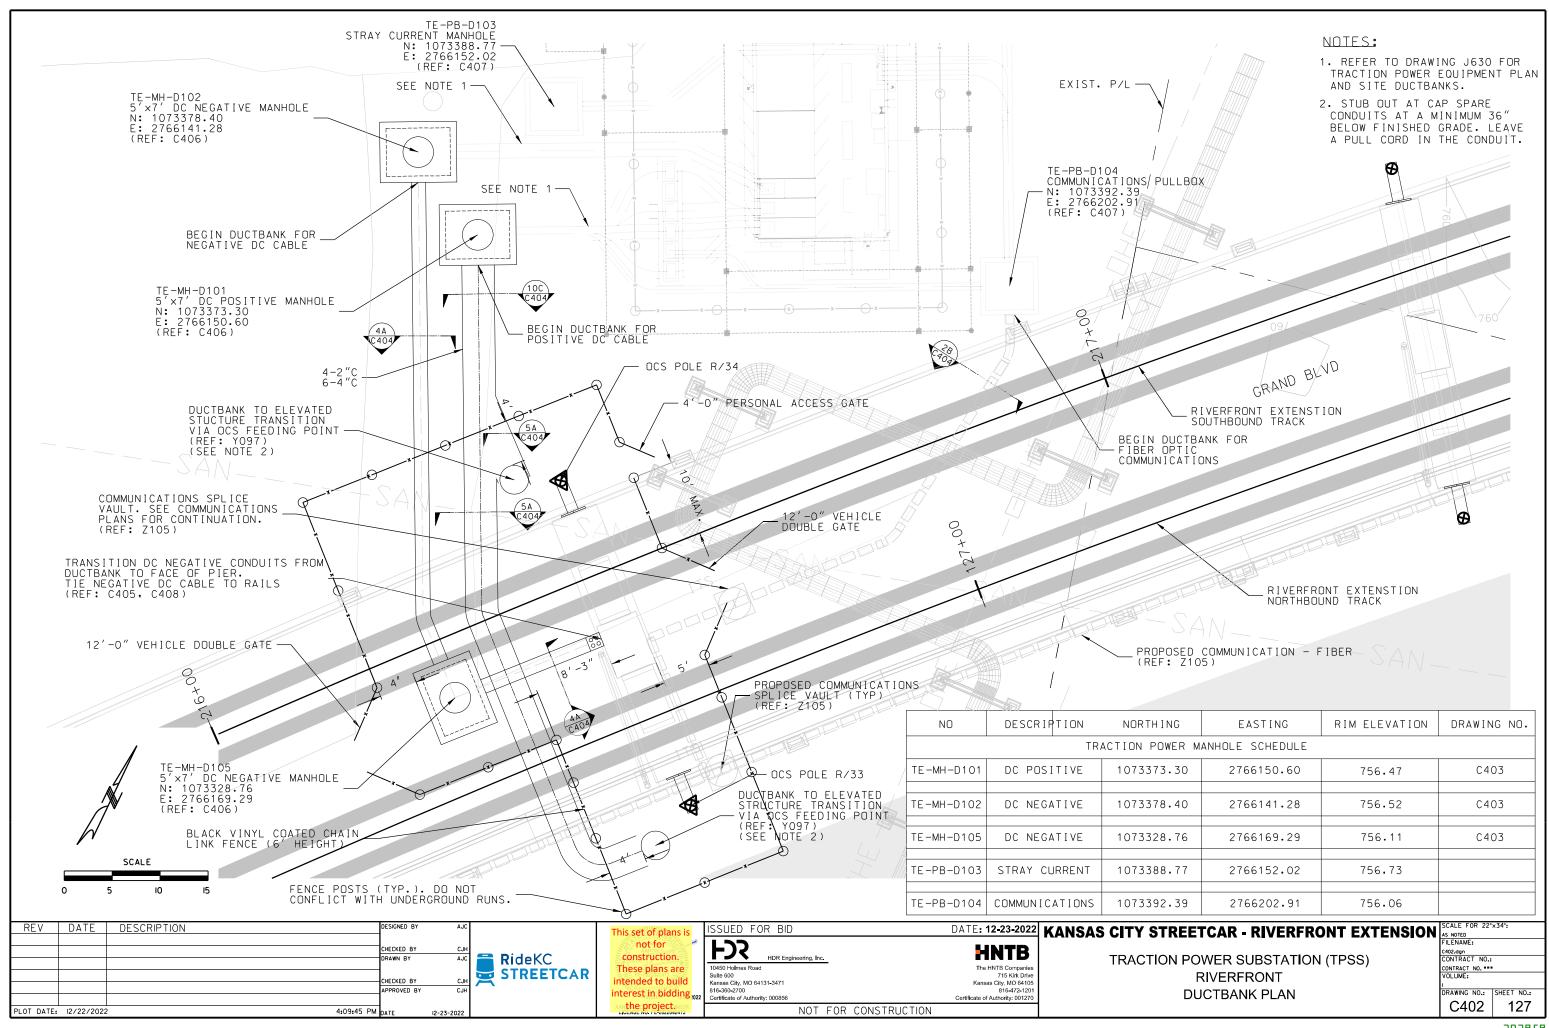

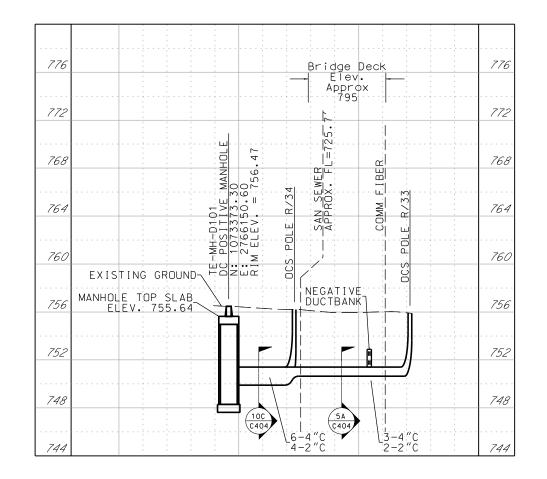

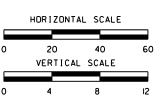

Bridge Deck Elev. Approx 795 776 776 772 772 TE-MH-D105 DC NEGATIVE MANHOLE N: 1073328.76 E: 2766169.29 RIM ELEV. = 756.11 768 768 SAN SEWER APPROX. FL TE-MH-D102 DC NEGATIVE N: 1073378. E: 2766141. RIM ELEV. 764 764 MANHOLE TOP SLAB /ELEV. 755.29 760 760 MANHOLE TOP SLAB ELEV. 755.68 EXISTING GROUND 756 756 752 752 4A C404 748 748 (4A) (C404) POST TTVE DUCTBANK 744 744

DC POSITIVE DUCTBANK

DC NEGATIVE DUCTBANK

REV	DATE	DESCRIPTION		DESIGNED BY	AJC		
				CHECKED BY	CJH		l
				DRAWN BY	AJC	RideKC	l
							l
				CHECKED BY	СЈН	STREETCAR	l
				APPROVED BY	CJH		l
				AFFROVED BI	CJn		l
							l
PLOT DATE:	12/22/2022		4:09:48 PM	DATE	12-23-2022		ı


This set of plans is not for	*
construction.	
These plans are intended to build	
interest in bidding.	022

ISSUED FOR BID	DATE: 12-23-2022
HDR Engineering, Inc.	HNTB
10450 Holmes Road	The HNTB Companies
Suite 600	715 Kirk Drive
Kansas City, MO 64131-3471	Kansas City, MO 64105
816-360-2700	816-472-1201
Certificate of Authority: 000856	Certificate of Authority: 001270

NOT FOR CONSTRUCTION

TRACTION POWER SUBSTATION (TPSS) **RIVERFRONT DUCTBANK PROFILE 1**


KANSAS CITY STREETCAR - RIVERFRONT EXTENSION SCALE FOR AS NOTED FILENAME: C403.dgn CONTRACT NO.: CONTRACT NO. ***
VOLUME: DRAWING NO.: SHEET NO.: C403 128

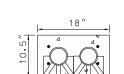


2 - 4" PVC (1H X 2W) SCALE: 1" = 1'-0"




2 - 2" PVC (1H X 2W) SCALE: 1" = 1'-0"

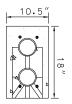


2 - 4" PVC (2H X 1W) SCALE: 1" = 1'-0"

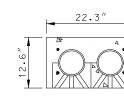

2 - 6" PVC (1H X 2W) SCALE: 1" = 1'-0"

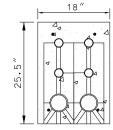


2 **-** 4" PVC AND 4 - 2" PVC (3H X 2W) SCALE: 1" = 1'-0"

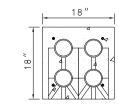


4A

4 - 4" PVC (2H X 2W) SCALE: 1" = 1'-0"

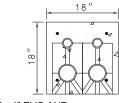

2 - 4" PVC AND 2 - 2" PVC (2H X 2W) SCALE: 1" = 1'-0"



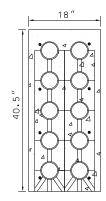

10 - 4" PVC (5H X 2W) SCALE: 1" = 1'-0"

-#4 HORIZONTAL REBAR CONTINUOUS, MINIMUM 2" COVER (TYP. OF ALL DUCTBANKS)


PVC CONDUITS

CONCRETE ENCASED DUCTBANK

TYPICAL REINFORCING DETAIL

SCALE: 1" = 1'-0"

2A

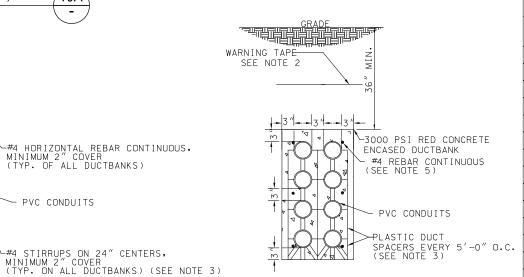

TYPICAL DUCTBANK CONFIGURATION CONCRETE ENCASED DUCTBANK SECTION SCALE: 1" = 1'-0

DUCTBANK REINFORCEMENT TABLE								
DB CON	FIGURATION	D (DEPTH) IN	W (WIDTH) IN	N (NUMBER OF LONGITUDINAL BARS)				
1 H	H X 2W	10.5	18.0	4				
1 H	H X 2W	9	14.0	4				
1 H	H X 3W	10.5	25.5	4				
1 H	H X 3W	9	20	4				
31	⊣ X 1W	20	9	4				
21	H X 2W	18.0	18.0	4				
1 H	H X 4W	10.5	33.0	6				
31	H X 2W	25.5	18.0	6				
21	Н X 3W	18.0	25.0	6				
41	H X 2W	33.0	18.0	6				
21	H X 4W	18.0	33.0	6				
1 ŀ	H X 8W	10.5	63.0	10				
51	H X 2W	40.5	18.0	8				
21	H X 5W	18.0	40.5	8				
1 H	X 10W	10.5	78.0	10				
1 H	X 10W	10.5	96.0	14				
21	4 X 4W	18	60	10				

NOT FOR CONSTRUCTION

NOTES:

- WHERE DIRECT BURIED CONDUITS INTERSECT CONCRETE ENCASED DUCTBANKS, COVER DEPTH FOR CONDUITS SHALL BE_ADJUSTED TO SUIT THE INSTALLATION AS APPROVED BY THE ENGINEER.
- PROVIDE DETECTABLE WARNING TAPE MINIMUM 9" DEPTH FROM SURFACE.
- STIRRUPS MAY BE REPLACED BY ADDING ADDITIONAL PLASTIC DUCT SPACERS AT INTERVALS OF 2.5 FT MAXIMUM SPACING AND CONNECTING HORIZONTAL REBAR TO THE SPACERS AT THE 2.5 FT MAXIMUM INTERVAL, PROVIDED NO METAL TOUCHES CONDUITS. THE SPACERS, WHICH CAN ACCOMMODATE THE REBAR CONNECTION/INSERTS SHALL BE SUBMITTED FOR APPROVAL AND APPROVED PRIOR TO INSTALLATION.
- 4. DUCTBANK CONFIGURATION MAY BE ADJUSTED AS NEEDED BY THE CONTRACTOR TO AVOID CONFLICTS WITH EXISTING UTILITIES AND/OR OTHER ELEMENTS. THE NUMBER AND SIZE OF CONDUITS SHALL NOT BE CHANGED WITHOUT APPROVAL BY THE ENGINEER.
- THE DUCTBANK LONGITUDINAL REBAR SHALL OVERLAP A MINIMUM OF 18 INCHES OR UTILIZE THREADED REBAR DOWELS. A MINIMUM OF FOUR REBARS OR 60 PERCENT OF THE LONGITUDINAL BARS SHALL BE EPOXY EMBEDDED 3 INCHES INTO A MANHOLE WALL.



REV	DATE	DESCRIPTION	DESIGNED BY	AJC		Т
			CHECKED BY	CJH		
			DRAWN BY	AJC		E
						4
			1		\sim	5
			CHECKED BY	CJH	$\boldsymbol{\prec}$	1
			APPROVED BY	CJH		
PLOT DATE:	12/22/2022	2 4:09:52 PM	DATE	12-23-2022		

RideKC **STREETCAR**

This set of plans not for construction. These plans are intended to build interest in bidding the project.

Certificate of Authority: 000856


SSUED FOR BID **FDS** 10450 Holmes Road Suite 600 Kansas City, MO 64131-3471 816-360-2700


DATE: 12-23-2022 HNTB The HNTB Companie 715 Kirk Driv Kansas City, MO 6410


816-472-120 Certificate of Authority: 001270


TRACTION POWER AND SCADA SYSTEM TYPICAL DUCTBANK SECTIONS


KANSAS CITY STREETCAR - RIVERFRONT EXTENSION SCALE FOR AS NOTED FILENAME: C404.dgn CONTRACT NO.: CONTRACT NO. ***
VOLUME: DRAWING NO.: SHEET NO.: C404 129

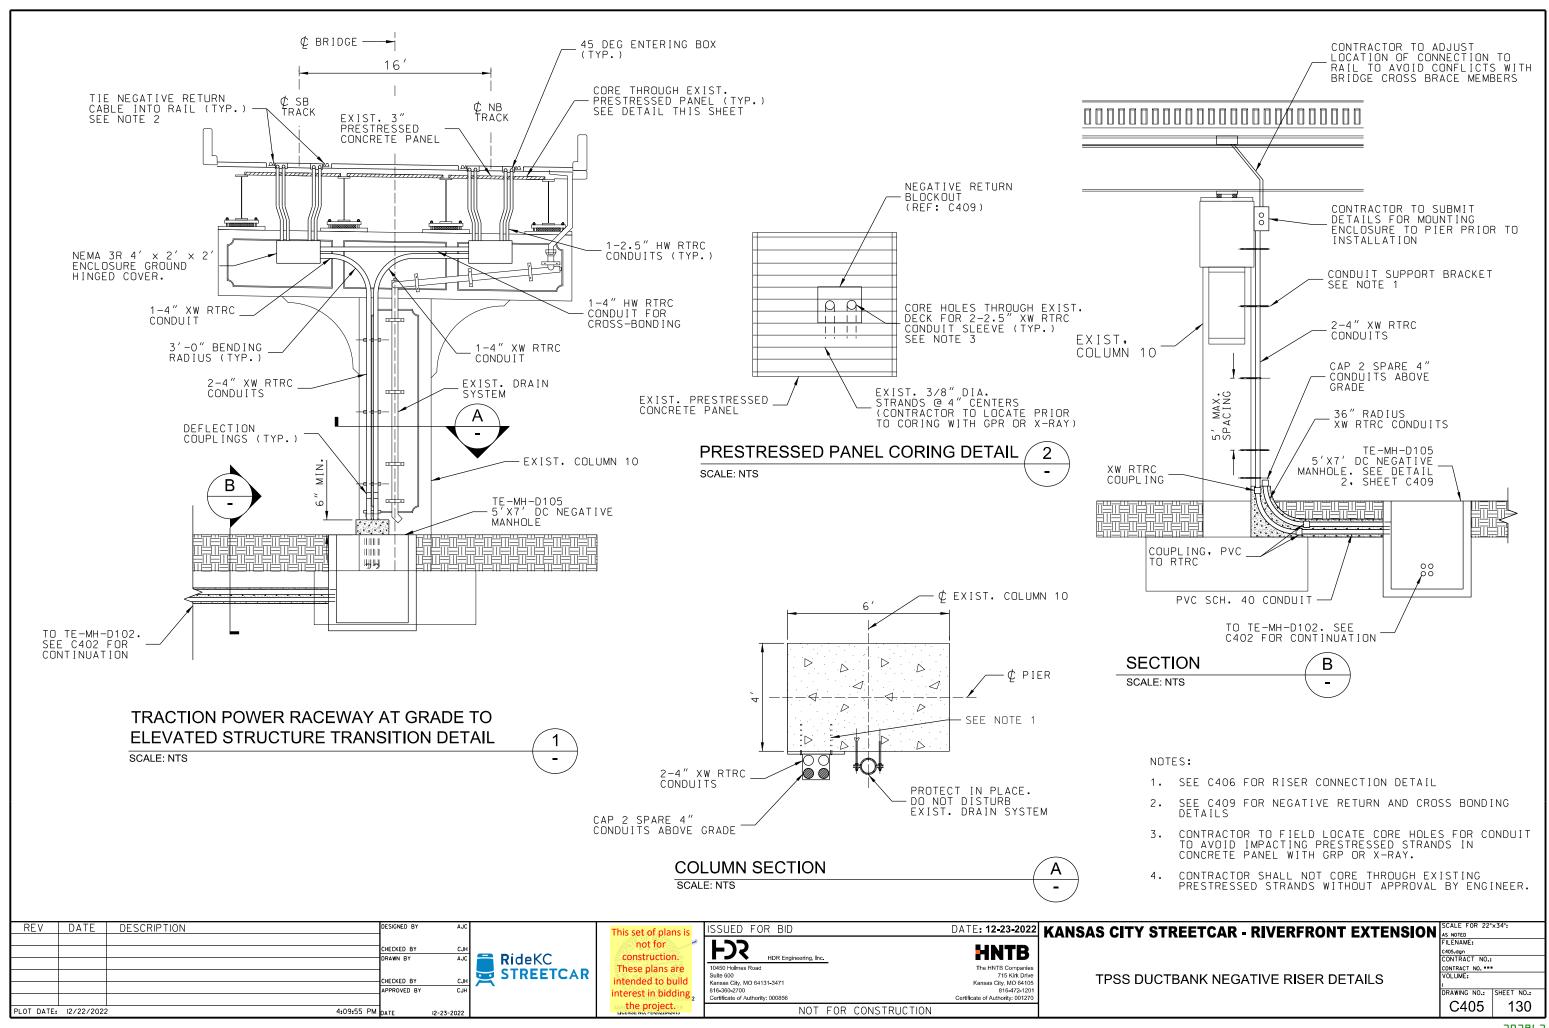


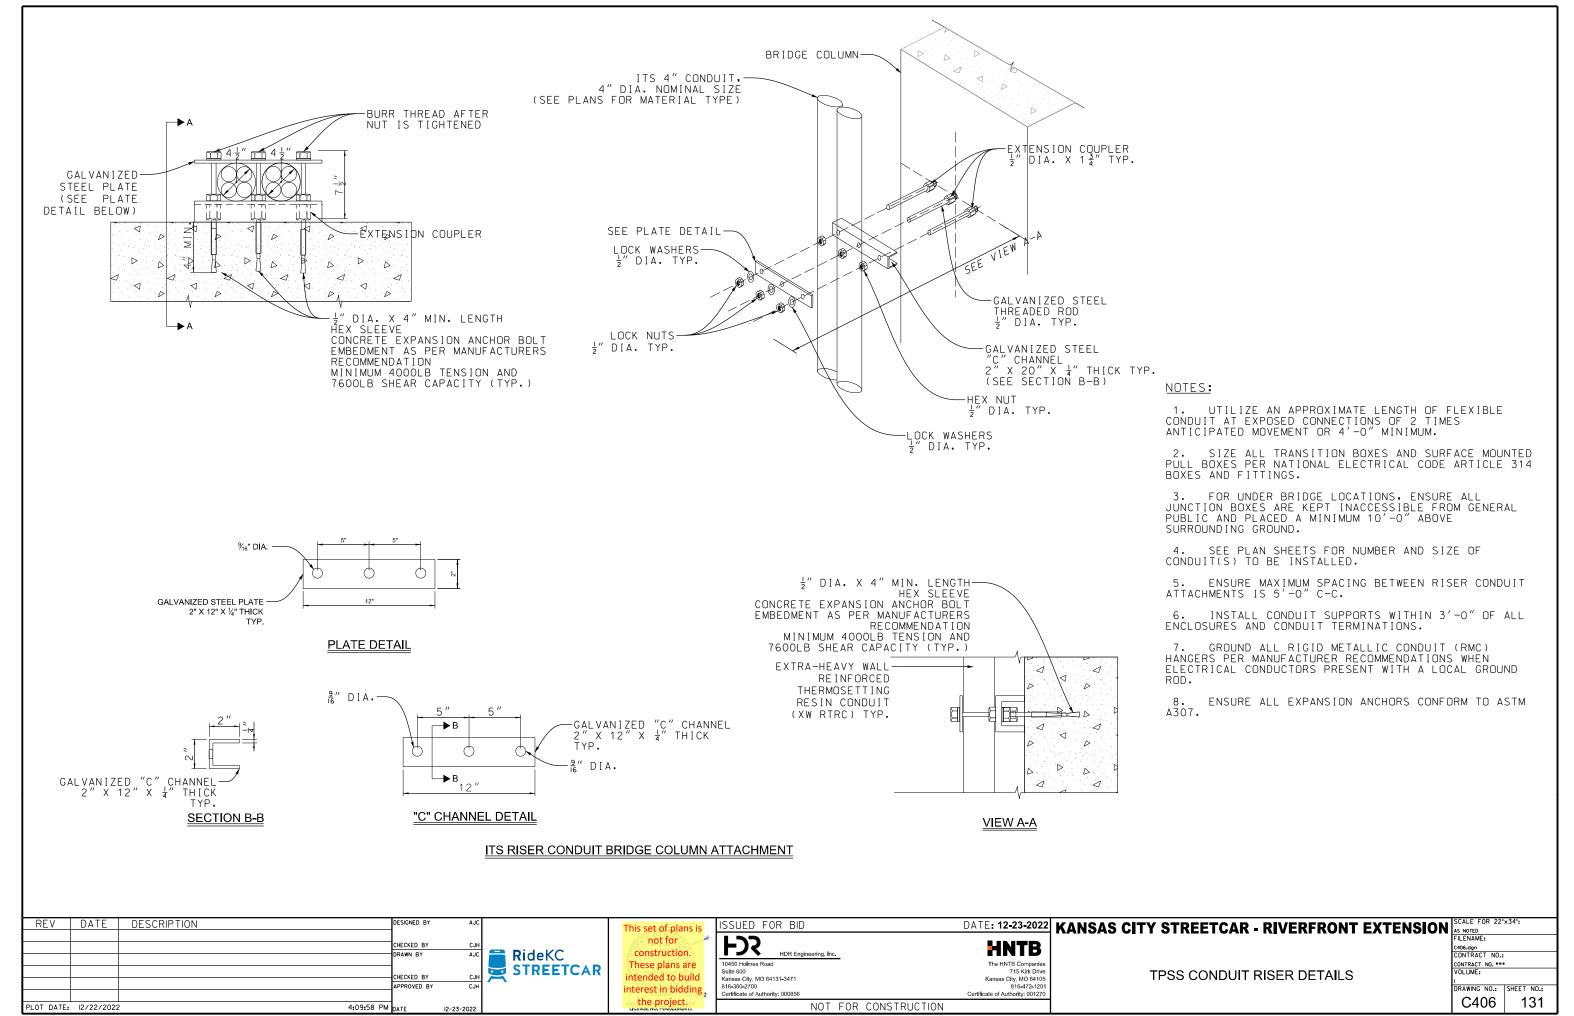


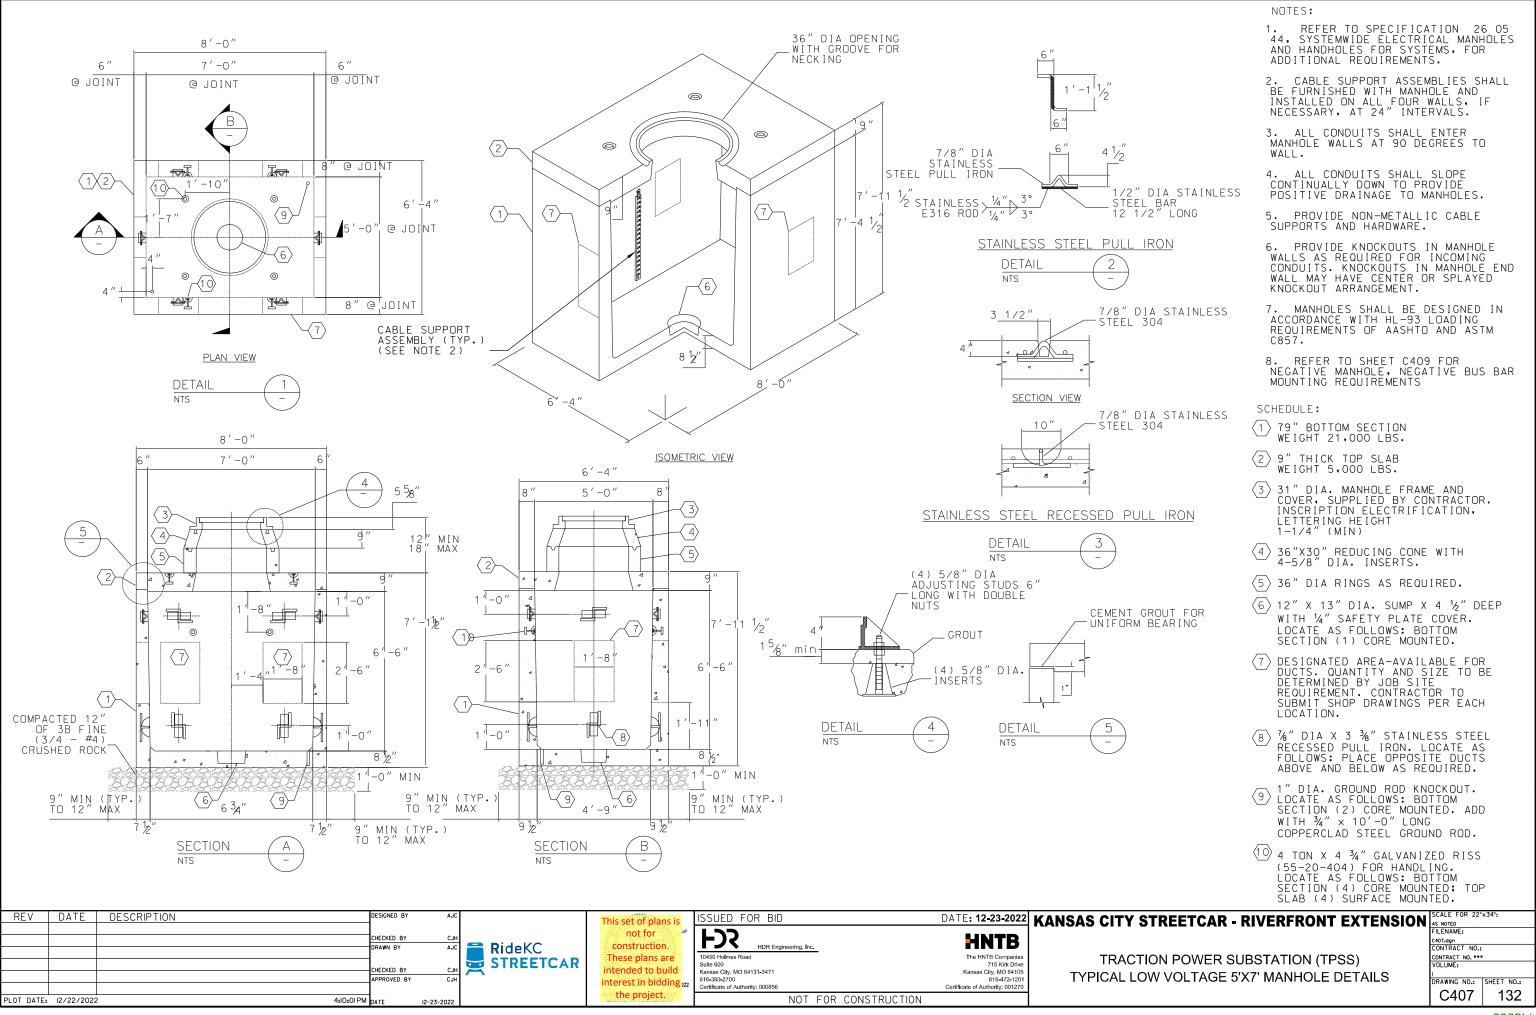


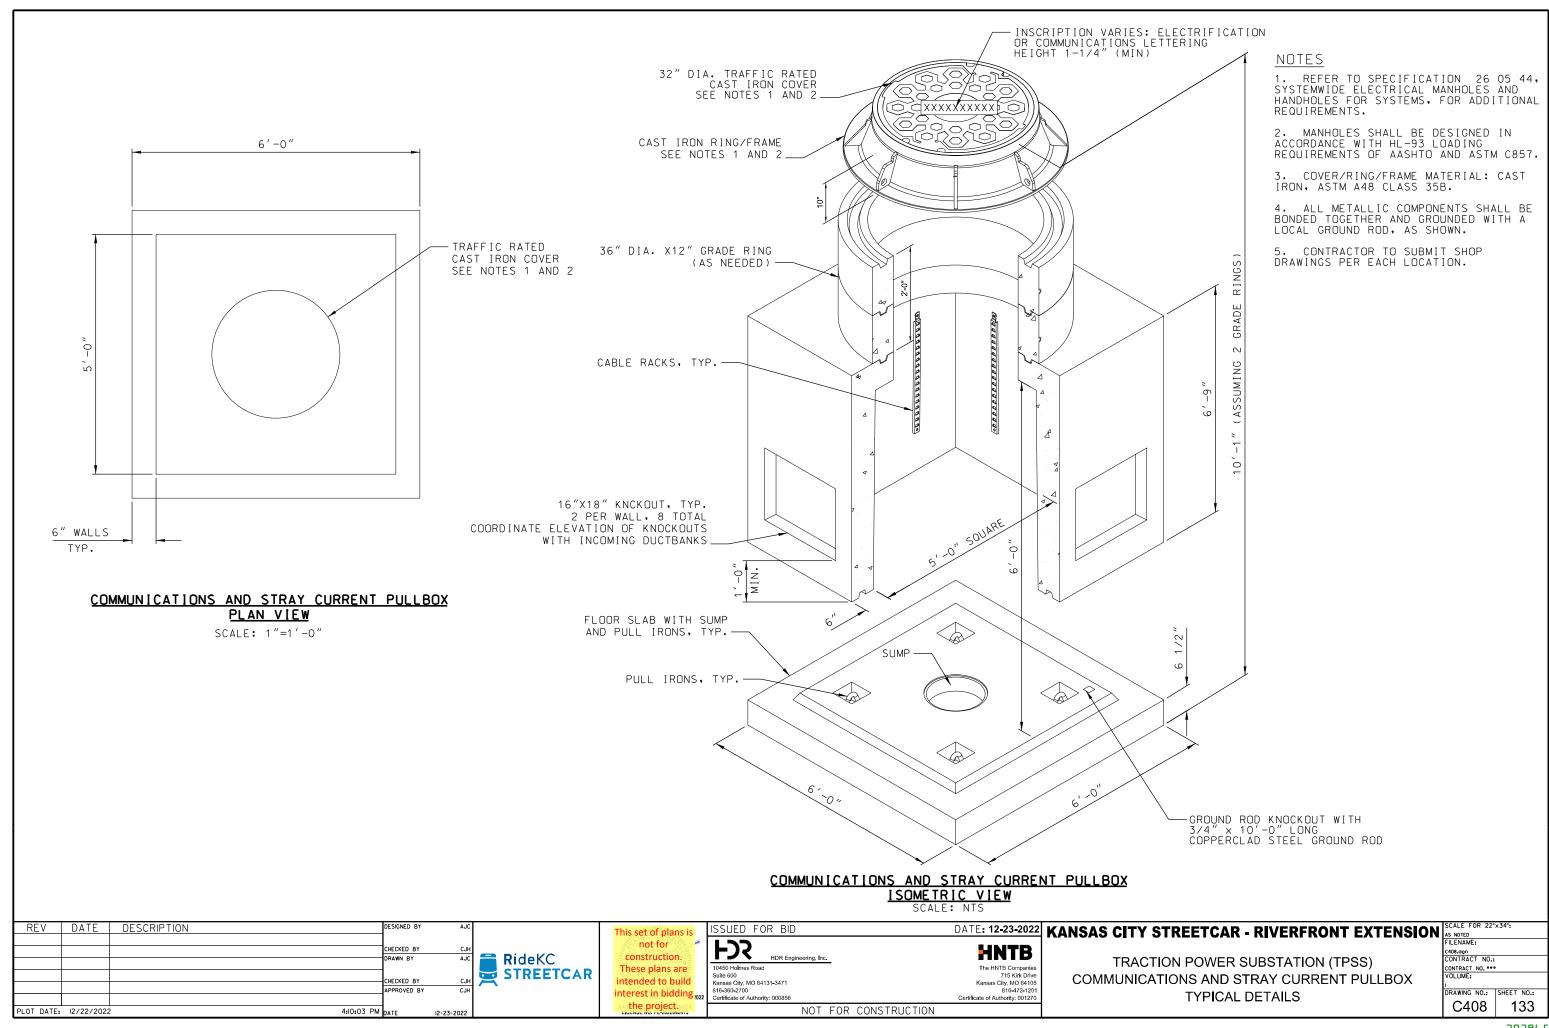


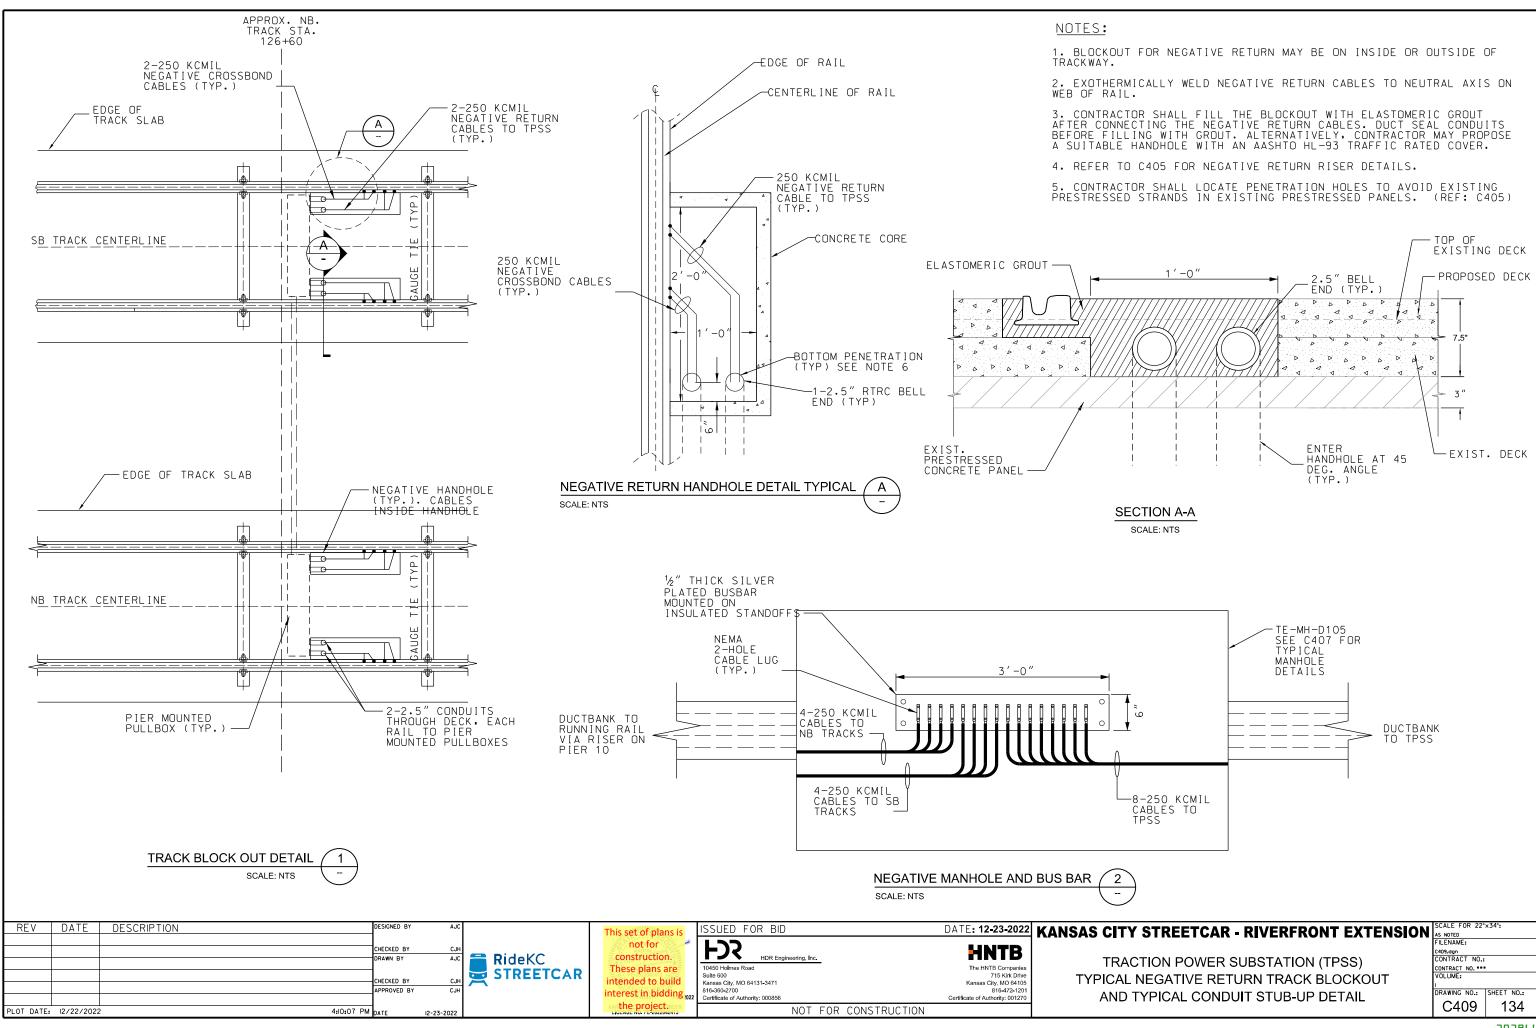


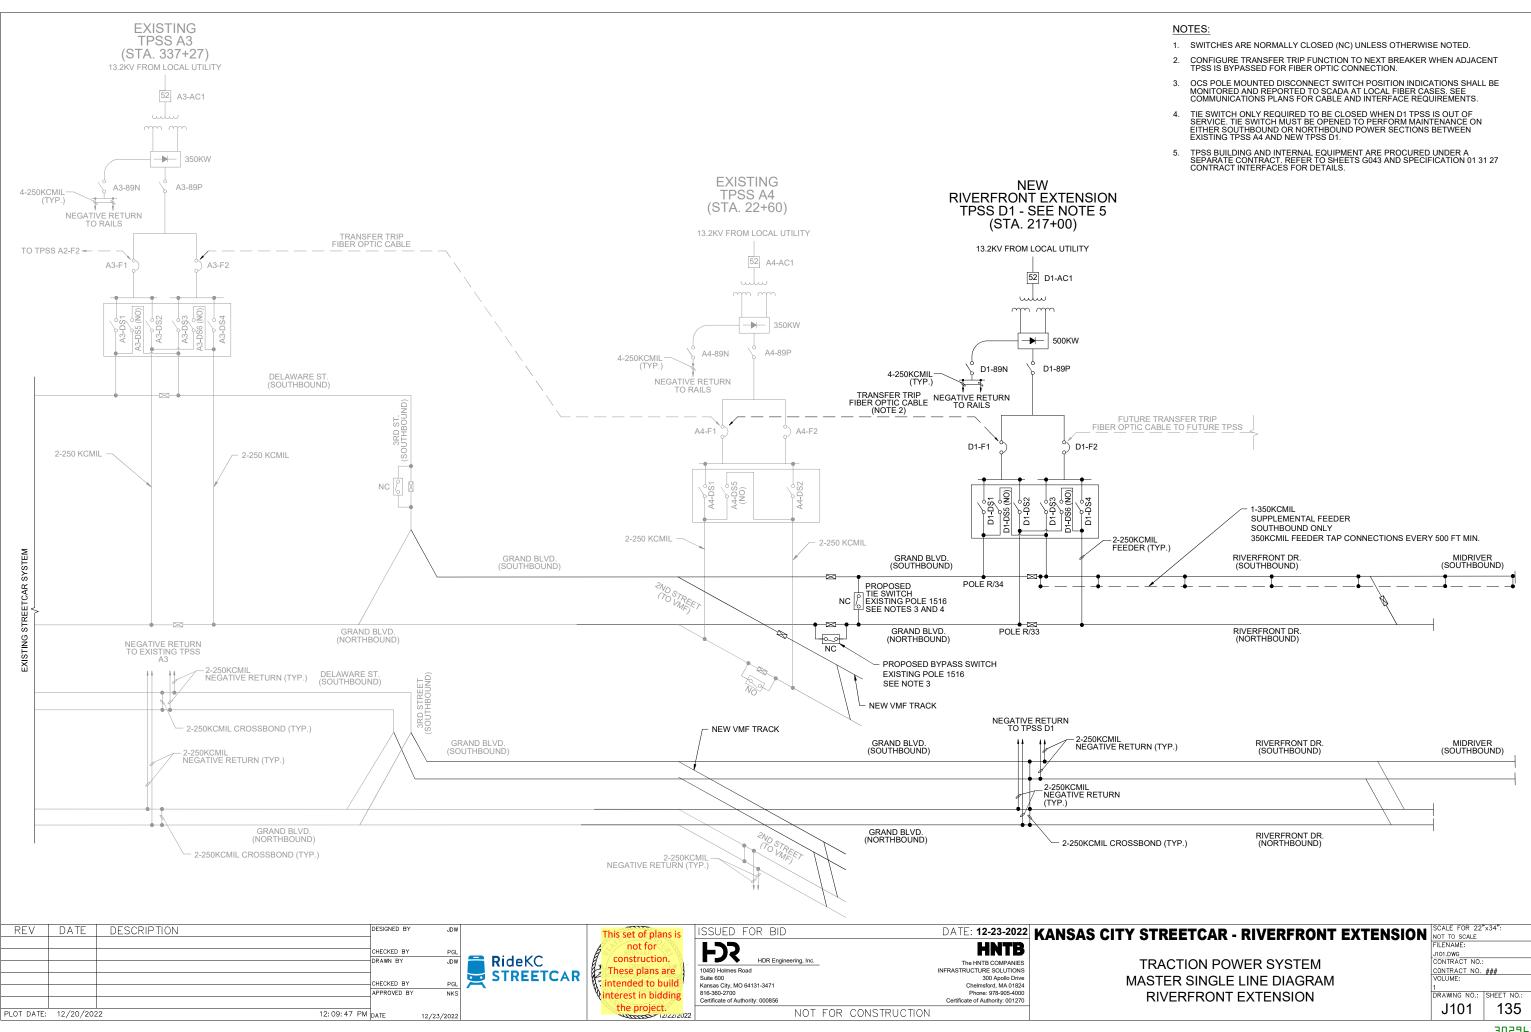


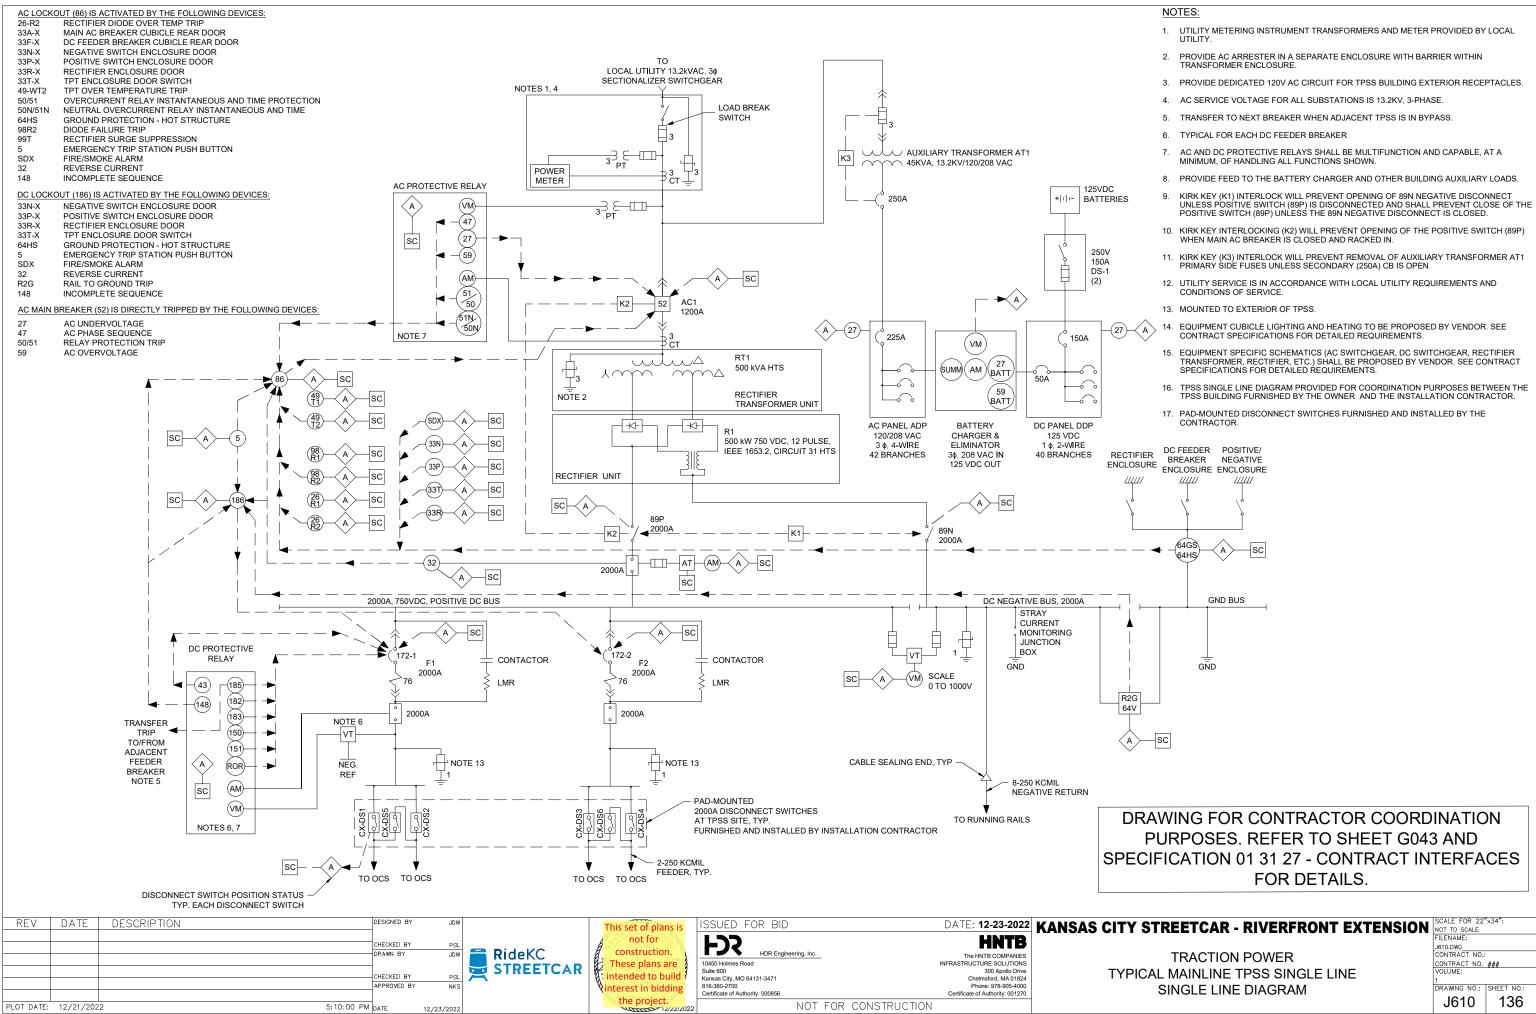

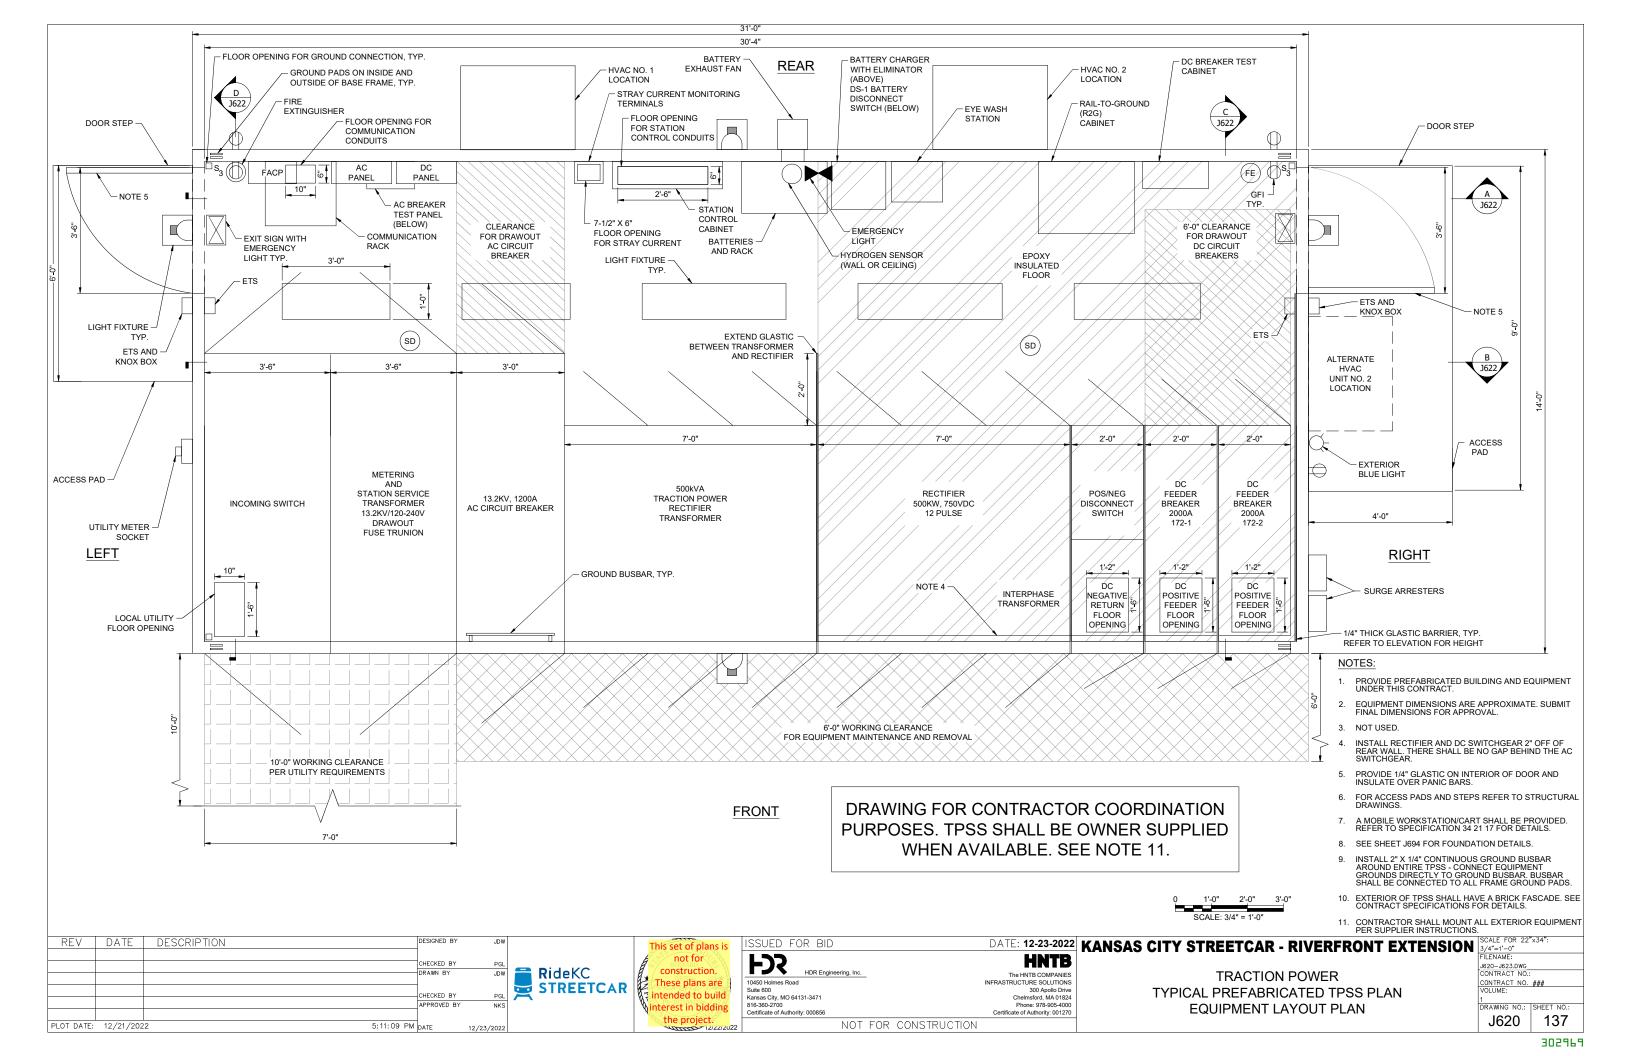

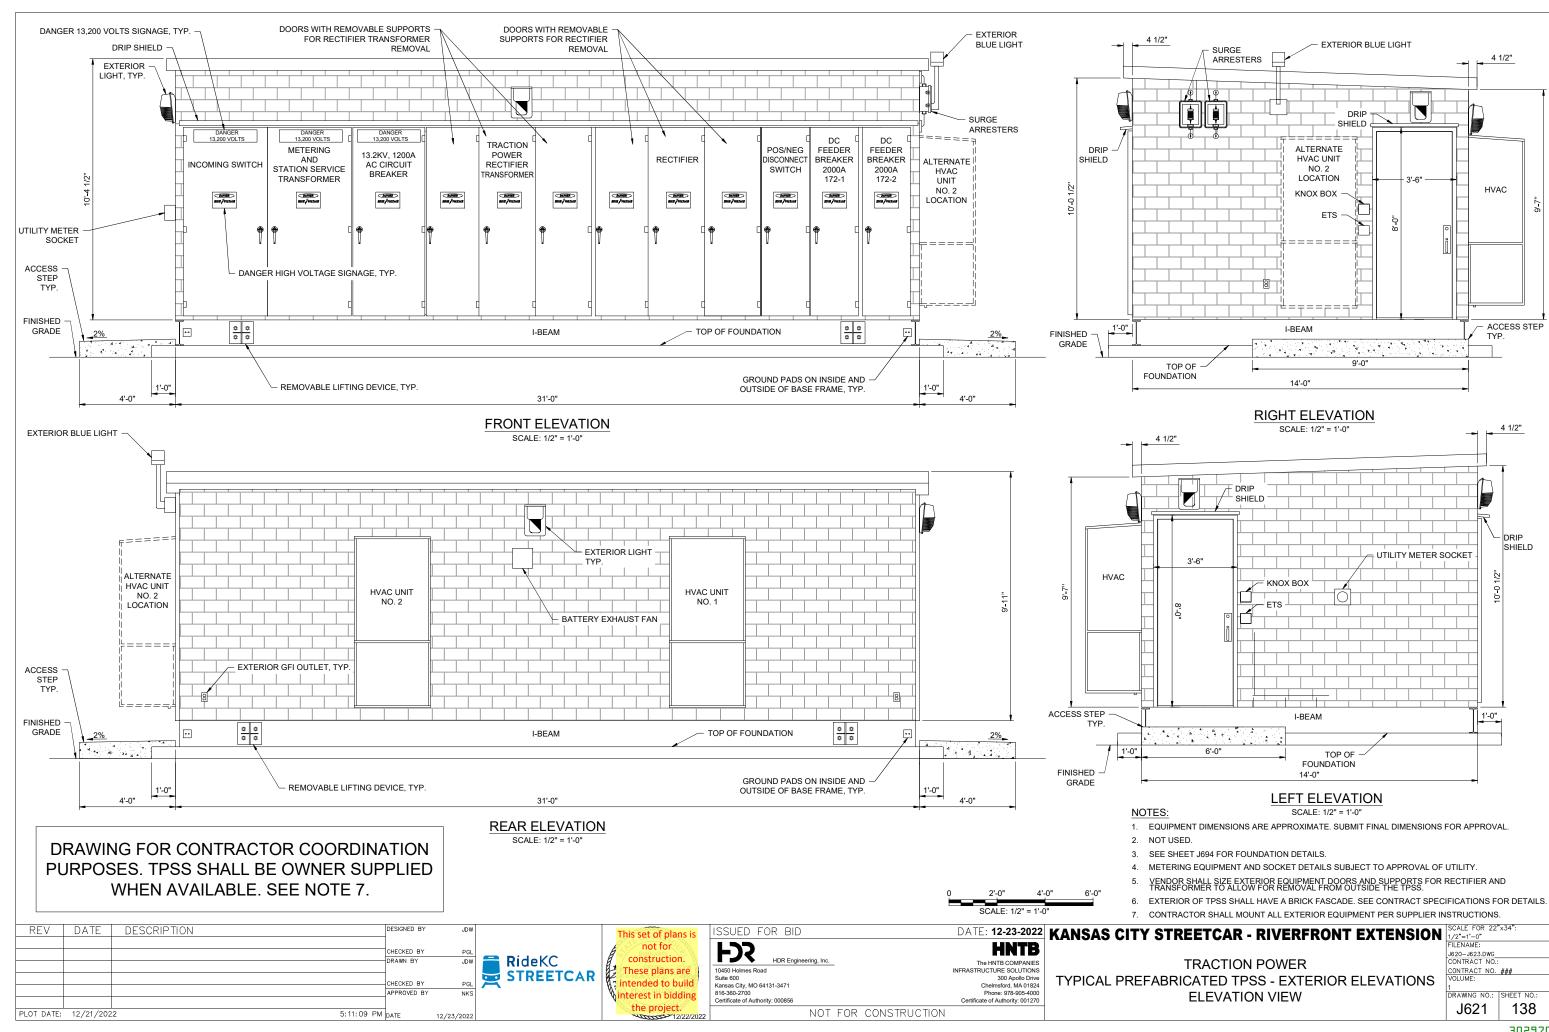

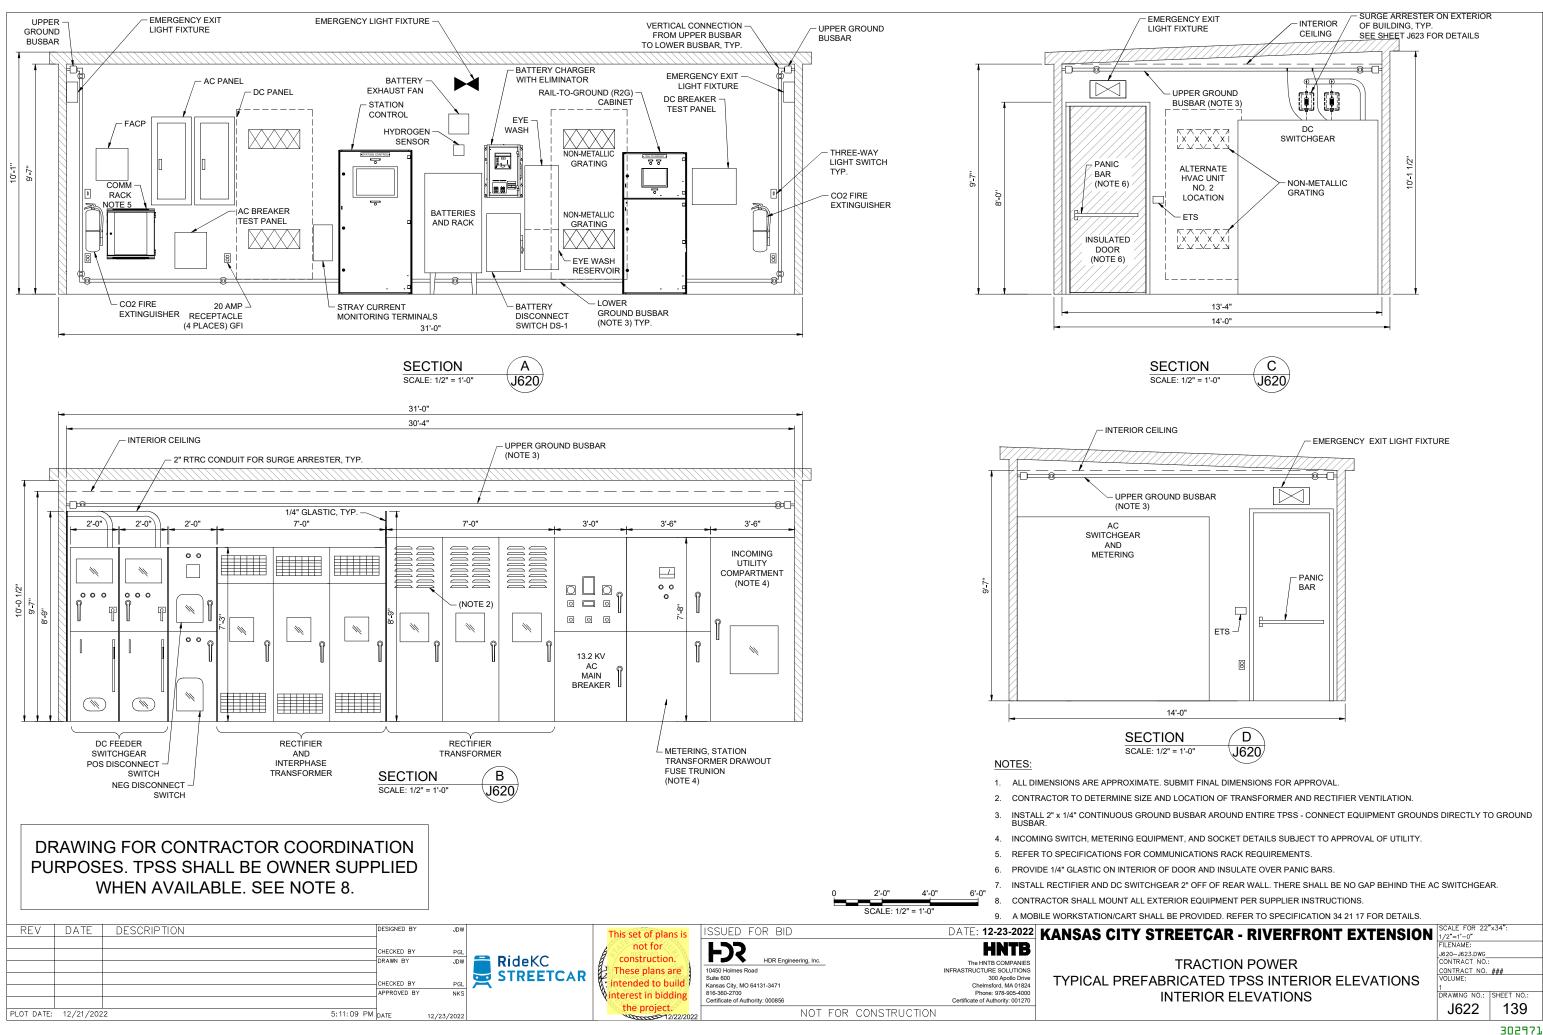

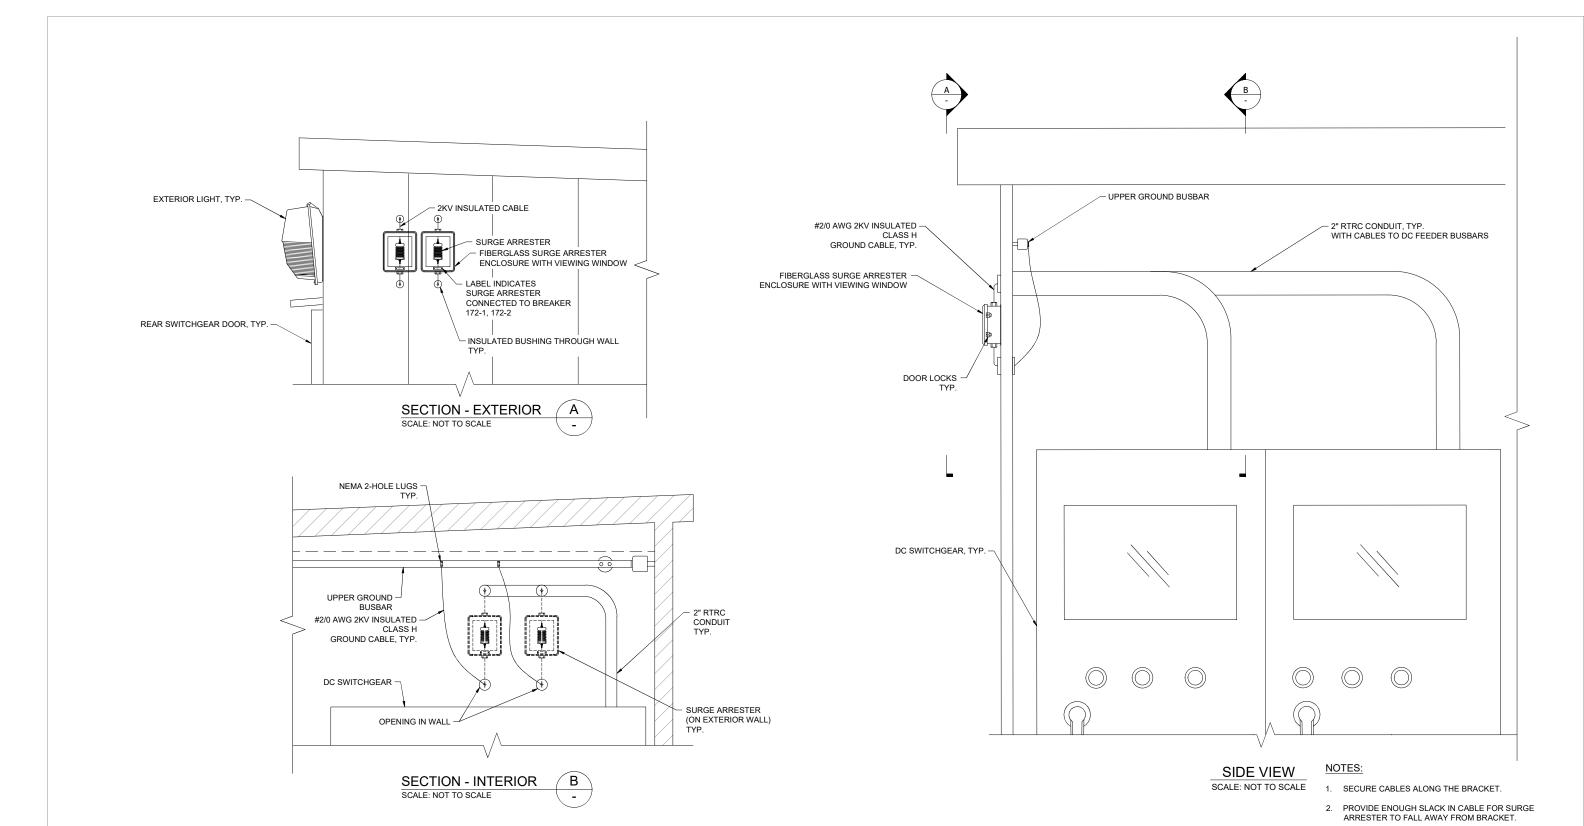

DRAWING FOR CONTRACTOR COORDINATION PURPOSES. TPSS SHALL BE OWNER SUPPLIED WHEN AVAILABLE. SEE NOTE 5.

REV DATE DESCRIPTION DESIGNED BY HECKED BY CHECKED BY APPROVED BY 5:11:09 PM DATE PLOT DATE: 12/21/2022

RideKC **STREETCAR**

This set of plans is not for These plans are tended to build nterest in bidding

ISSUED FOR BID 10450 Holmes Road Suite 600 Kansas City, MO 64131-3471 816-360-2700 Certificate of Authority: 000856 NOT FOR CONSTRUCTION

Chelmsford, MA 01824 Phone: 978-905-4000

Certificate of Authority: 001270

DATE: 12-23-2022
HNTB
The HNTB COMPANIES

HANSAS CITY STREETCAR - RIVERFRONT EXTENSION SCALE FOR 22"x34": NOT TO SCALE FILENAME: US20-J023.DWG CONTRACT NO.:

TRACTION POWER TYPICAL SURGER ARRESTER **INTERIOR ELEVATIONS**


CONTRACT NO. ###
VOLUME:


3. PROVIDE FIBERGLASS ENCLOSURE WITH VIEWING


4. SURGE ARRESTERS SHALL BE MOUNTED AT A

5. CONTRACTOR SHALL MOUNT ALL EXTERIOR EQUIPMENT PER SUPPLIER INSTRUCTIONS.

WINDOW AND DOOR LOCKS.

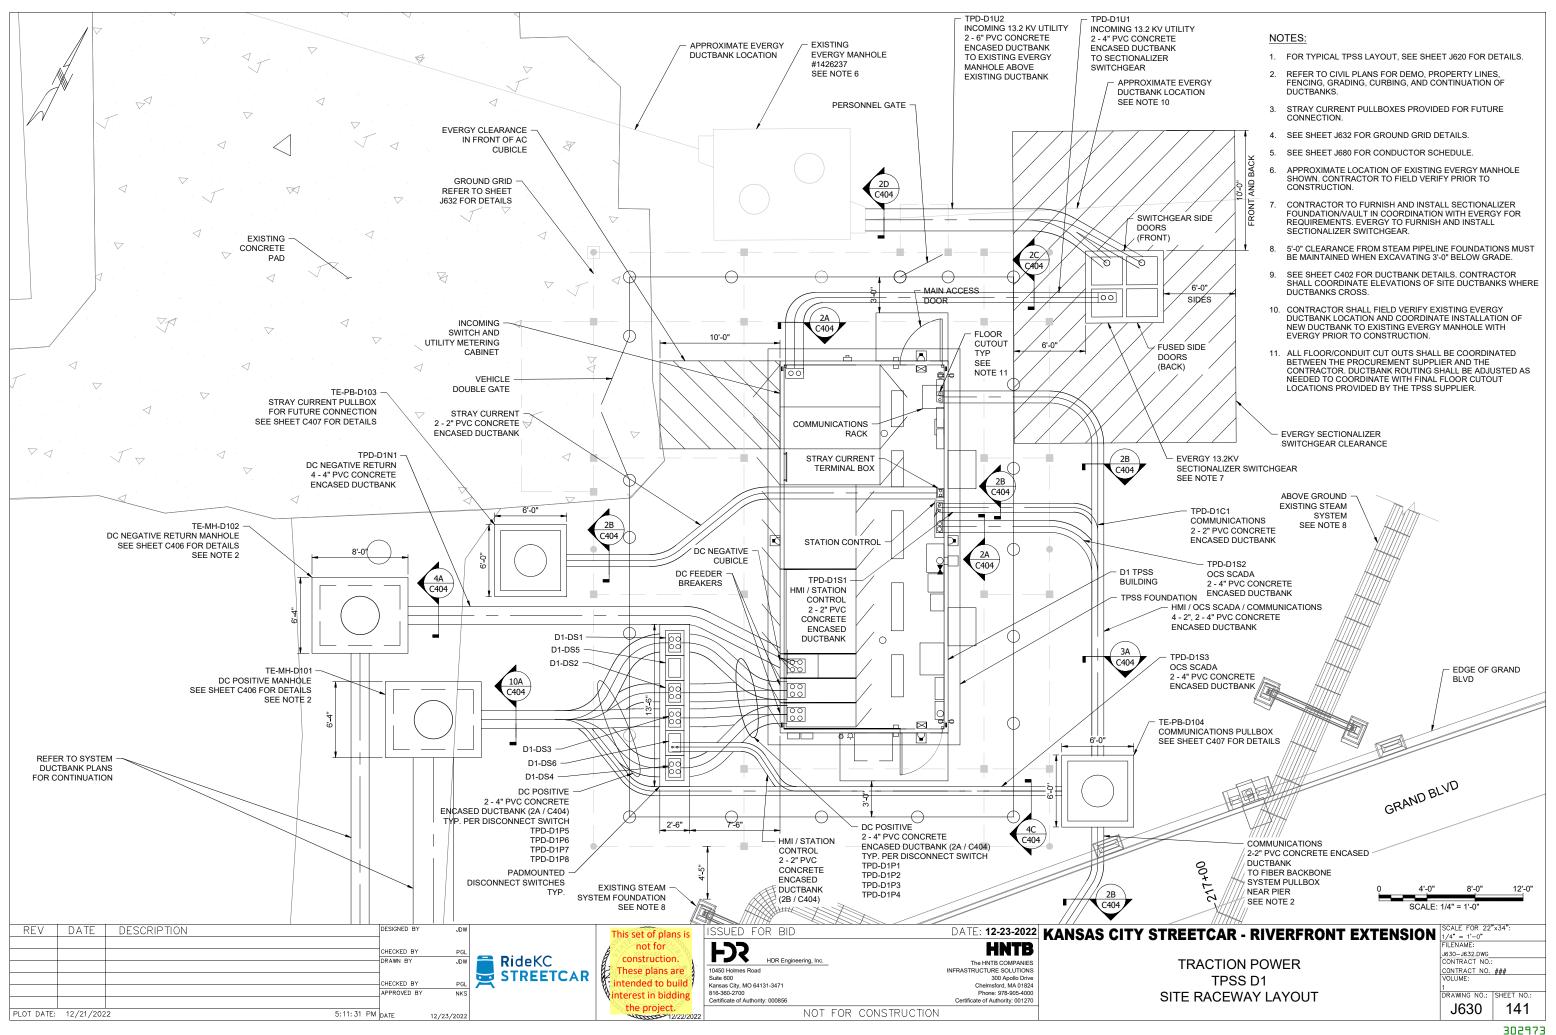

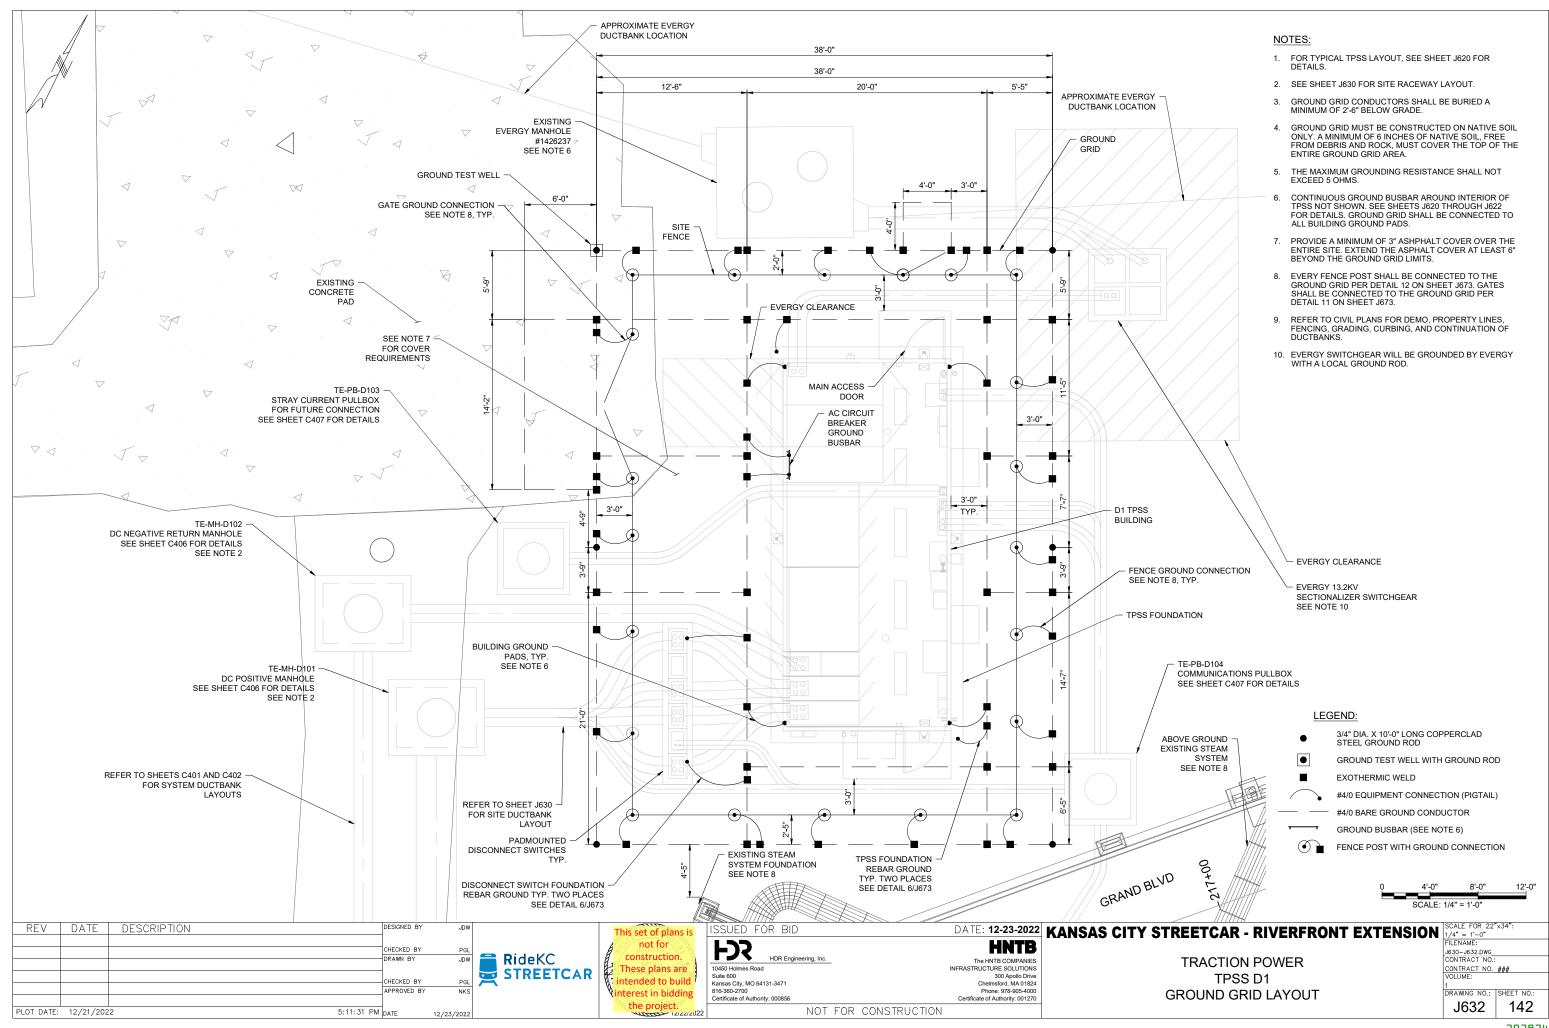

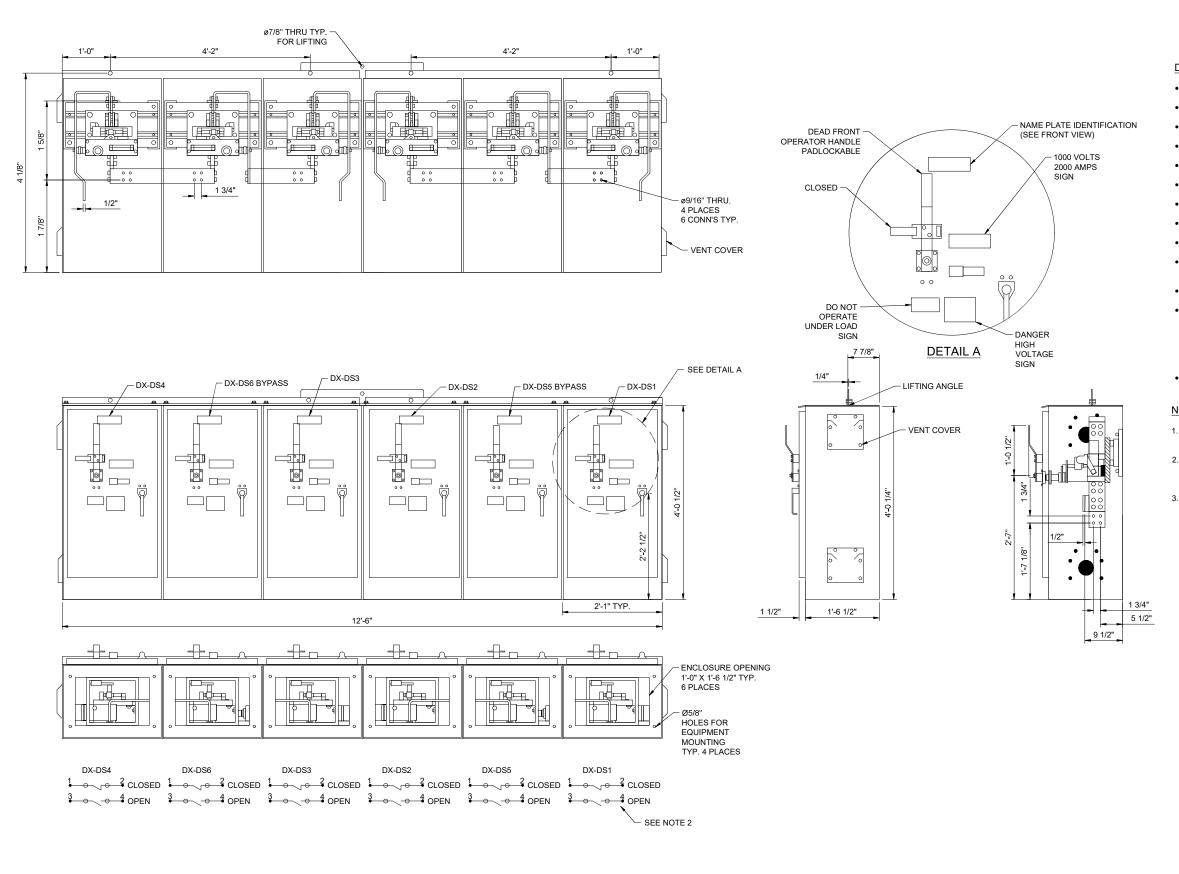

ISSUED FOR BID

10450 Holmes Road Suite 600

816-360-2700

Kansas City, MO 64131-3471

Certificate of Authority: 000856

not for

These plans are

tended to build

terest in bidding

DESIGNED BY

HECKED BY

CHECKED BY

APPROVED B

5:11:46 PM DATE

RideKC

STREETCAR

REV DATE DESCRIPTION

PLOT DATE: 12/21/2022

DISCONNECT SWITCH FEATURES:

- (6) 2000 AMP DISCONNECT SWITCHES
- 1000VDC SWITCH & BUSBAR INSULATION RATING
- SINGLE POLE, SINGLE THROW, BOLTED PRESSURE TYPE SWITCHES
- NON-FUSIBLE
- NON-LOAD BREAK OPERATION
- 2000 AMP MAIN BUSBAR CAPACITY
- SILVER PLATED TERMINALS
- 1 NO./NC AUX . CONTACT FOR POSITION INDICATION
- FRONT OPERATED WITH PADLOCK FEATURE
- OPERATOR HANDLE AND DOOR ARE MECHANICALLY INTERLOCKED TO PREVENT DOOR OPENING WITH THE SWITCH IN THE CLOSED POSITION
- OPERATOR HANDLE GROUNDED
- NEMA 4X PAD MOUNTED FIBERGLASS ENCLOSURE:

ANSI 61 GRAY EXTERIOR AND WHITE INTERIOR CONTINUOUS STAINLESS STEEL HINGE DOOR PERIMETER IS FULLY GASKETED 3 POINT HANDLE IS PADLOCKABLE

• APPROX. WT. - 1500 LBS

NOTES:

- DIMENSIONS PROVIDED ARE TYPICAL. FINAL DIMENSIONS SHALL BE DETERMINED BY DISCONNECT SWITCH MANUFACTURER
- 2. EACH DISCONNECT SWITCH POSITION STATUS INDICATIONS SHALL BE REPORTED TO THE SAS PLC. SEE SITE SPECIFIC CONDUCTOR SCHEDULE FOR
- 3. PAD-MOUNTED DISCONNECT SWITCHES FURNISHED AND INSTALLED BY THE CONTRACTOR.

DATE: 12-23-2022 KANSAS CITY STREETCAR - RIVERFRONT EXTENSION SCALE FOR 22"x34": NOT TO SCALE FILENAME:

HNTB

Chelmsford, MA 01824

Certificate of Authority: 001270

NOT FOR CONSTRUCTION

Phone: 978-905-4000

TRACTION POWER TYPICAL DISCONNECT SWITCH ARRANGEMENT

J640.DWG CONTRACT NO.: CONTRACT NO. ###
VOLUME: DRAWING NO.:

FROM AUXILIARY POWER TRANSFORMER AT1 NOTE 2 AC PANEL ADP 208/120 VAC PANEL 3φ, 4W, 42 CIRCUIT 27)-МСВ 225A, 3P L 9 - 9 - 9 - 1 TYPE 2 SPD LOAD KVA CKT. Αφ Βφ Cφ NO. CB SIZE AMPS CKT. NO. LOAD KVA LOAD DESCRIPTION LOAD DESCRIPTION Сф Вф Аф EXTERIOR LIGHTS 2 INTERIOR LIGHTS 20A 20A INTERIOR EXTERIOR 20A 20A 4 3 RECEPTACLES RECEPTACLES 6 HVAC #1 60A 60A 8 HVAC #2 AC SWITCHGEAR 11 12 20A HEATER STRIPS BATTERY CHARGER 13 60A 20A 14 EXHAUST FAN 20A 16 SMOKE DETECTOR DC SWITCHGEAR 17 20A 18 FIRE ALARM PANEL 20A HEATER STRIPS EXIT LIGHTS/ 19 20A SWITCHGEAR LIGHTS 20A 20 **EMERGENCY LIGHT** 22 SPARE 23 60A 60A 24 SPARE 25 26 RECTIFIER 27 20A 20A 28 RECTIFIER HEATERS TRANSFORMER 20A RECTIFIER LIGHTS SPARE 29 20A 30 SPARE 31 20A 20A 32 SPARE 33 SPACE SPACE 34 SPACE 35 SPACE 36 SPACE 37 38 SPACE

AC PANEL ADP - PANEL SCHEDULE

40

42

NOT FOR CONSTRUCTION

SCALE: NOT TO SCALE

NOTES:

- 1. FOR COORDINATION PURPOSES ONLY. REFER TO VENDOR'S AC PANELBOARD DRAWING FOR AC PANEL LAYOUT
- ALL INTERNAL BUILDING WIRING AND FINAL BREAKER SIZES TO BE DETERMINED BY VENDOR (OWNER SUPPLIED) IN COORDINATION WITH THE CONTRACTOR (THIS CONTRACT).
- 3. SHOP DRAWINGS TO BE PROVIDED BY THE OWNER WHEN AVAILABLE.
- DRAWING FOR CONTRACTOR COORDINATION PURPOSES. TPSS SHALL BE OWNER SUPPLIED AND SHOP DRAWINGS SUPPLIED WHEN AVAILABLE.

DRAWING FOR CONTRACTOR COORDINATION PURPOSES. TPSS SHALL BE OWNER SUPPLIED WHEN AVAILABLE.

REV	DATE	DESCRIPTION	DESIGNED BY	JDW
			CHECKED BY	PGL
			DRAWN BY	JDW
			4	
			CHECKED BY	PGL
			APPROVED BY	NKS
PLOT DATE:	12/21/202	2 5:12:22 PM	T _{DATE}	10 /07 /0000



SPACE

SPACE

This set of plans is These plans are tended to build interest in bidding

39

ISSUED FOR BID 10450 Holmes Road Suite 600 Kansas City, MO 64131-3471 816-360-2700 Certificate of Authority: 000856

Chelmsford, MA 01824 Phone: 978-905-4000

Certificate of Authority: 001270


SPACE

SPACE

TRACTION POWER 120/208V AC PANEL ADP PANEL SCHEDULE

DATE: 12-23-2022 KANSAS CITY STREETCAR - RIVERFRONT EXTENSION SCALE FOR 22"x34" NOT TO SCALE FILENAME: J642.DWG CONTRACT NO.: CONTRACT NO. ###
VOLUME:

DRAWING NO.: J642 144

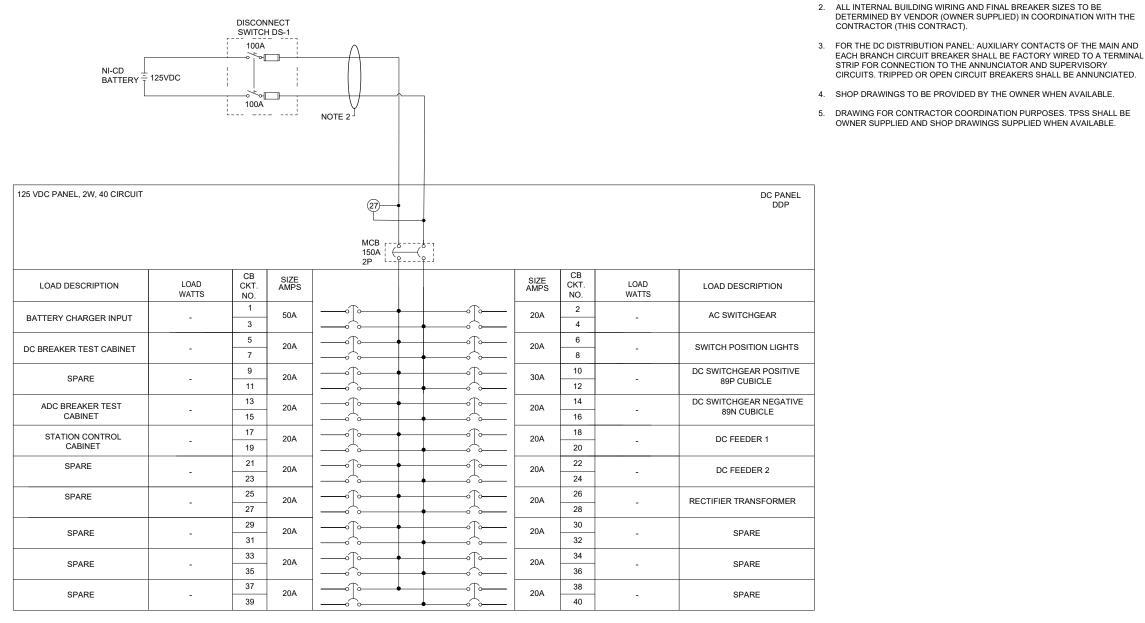

DC PANEL DDP - PANEL SCHEDULE SCALE: NOT TO SCALE

> DRAWING FOR CONTRACTOR COORDINATION PURPOSES. TPSS SHALL BE OWNER SUPPLIED WHEN AVAILABLE.

REV	DATE	DESCRIPTION		DESIGNED BY	JDW	
				CHECKED BY	PGL	
				DRAWN BY	JDW	ı
				-		
				CHECKED BY	PGL	. 5
				APPROVED BY	NKS	ĺ
PLOT DATE:	12/21/202	2	5:12:50 PM	DATE	12/23/2022	

RideKC **STREETCAR** This set of plans is These plans are tended to build nterest in bidding

ISSUED FOR BID 10450 Holmes Road Suite 600 Kansas City, MO 64131-3471 816-360-2700 Certificate of Authority: 000856

NOT FOR CONSTRUCTION

Chelmsford, MA 01824 Phone: 978-905-4000

Certificate of Authority: 001270

TRACTION POWER 125V DC PANEL DDP PANEL SCHEDULE


NOTES:


1. FOR COORDINATION PURPOSES ONLY. REFER TO VENDOR'S AC PANELBOARD DRAWING FOR AC PANEL LAYOUT


DATE: 12-23-2022 KANSAS CITY STREETCAR - RIVERFRONT EXTENSION SCALE FOR 22"x34" NOT TO SCALE FILENAME: J643.DWG CONTRACT NO.: CONTRACT NO. ###
VOLUME: DRAWING NO.:

J643

- FINAL SCHEMATICS, LOGIC, AND FUNCTIONAL REQUIREMENTS SHALL BE DEVELOPED BY THE
- 2. EQUIPMENT CUBICLE LIGHTING AND HEATING TO BE PROPOSED BY VENDOR. SEE SHOP DRAWINGS SUPPLIED BY BUILDING VENDOR VIA OWNER.
- 3. EQUIPMENT SPECIFIC SCHEMATICS (AC SWITCHGEAR, DC SWITCHGEAR, RECTIFIER TRANSFORMER, RECTIFIER, ETC.) SHALL BE PROPOSED BY VENDOR. SEE SHOP DRAWINGS SUPPLIED BY BUILDING VENDOR VIA OWNER.

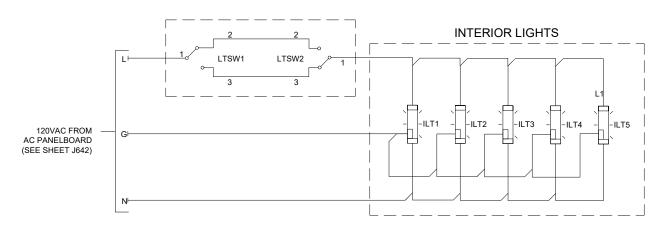

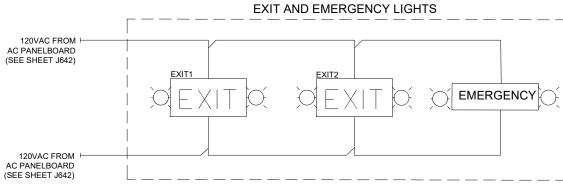

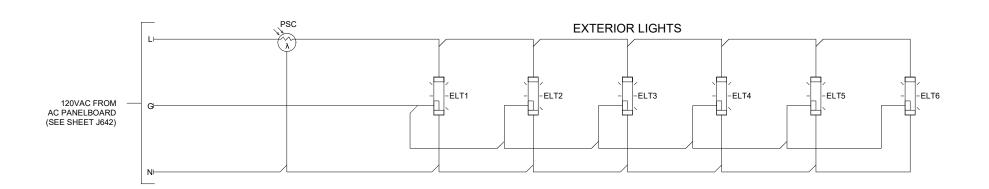

DRAWING FOR CONTRACTOR COORDINATION PURPOSES. TPSS SHALL BE OWNER SUPPLIED WHEN AVAILABLE.

REV DATE DESCRIPTION DESIGNED BY HECKED BY CHECKED BY APPROVED BY PLOT DATE: 12/21/2022 5:13:15 PM DATE

RideKC **STREETCAR** This set of plans is not for These plans are

ISSUED FOR BID 10450 Holmes Road Suite 600 Kansas City, MO 64131-3471 816-360-2700 Certificate of Authority: 000856

The HNTB COMPANIES INFRASTRUCTURE SOLUTIONS 300 Apollo Drive Chelmsford, MA 01824 Phone: 978-905-4000 Certificate of Authority: 001270

NOT FOR CONSTRUCTION

DATE: 12-23-2022

HNTB
The HINTB COMPANIES
INFRASTRICITIES SOLUTIONS
TRACTION POWER


SCALE FOR 22"x34":
NOT TO SCALE
FILENAME:
J644.DWG
CONTRACT NO:


TYPICAL TPSS LIGHTING SCHEMATIC


CONTRACT NO. ###
VOLUME:

DRAWING NO.: J644 146

- 1. FINAL SCHEMATICS, LOGIC, AND FUNCTIONAL REQUIREMENTS SHALL BE DEVELOPED BY THE VENDOR. SEE SHOP DRAWING SUPPLIED BY BUILDING VENDOR VIA OWNER.
- 2. EQUIPMENT SPECIFIC SCHEMATICS (AC SWITCHGEAR, DC SWITCHGEAR, RECTIFIER TRANSFORMER, RECTIFIER, ETC.) SHALL BE PROPOSED BY VENDOR. SEE SHOP DRAWINGS SUPPLIED BY BUILDING VENDOR VIA OWNER.

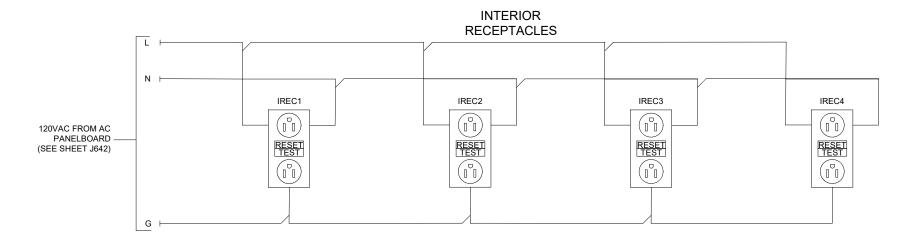

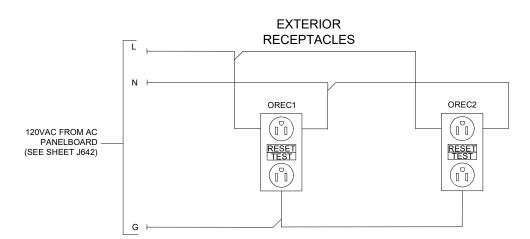

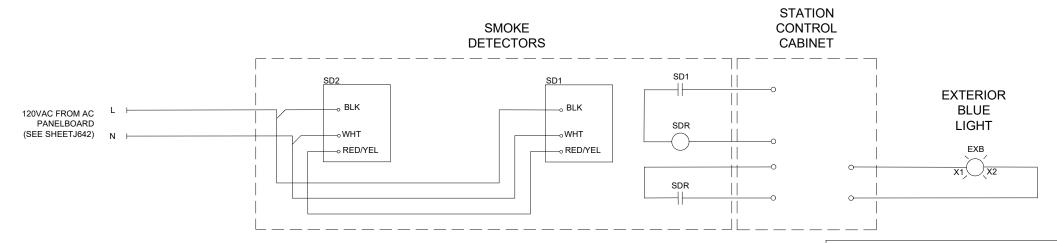

DRAWING FOR CONTRACTOR COORDINATION PURPOSES. TPSS SHALL BE OWNER SUPPLIED WHEN AVAILABLE.

REV	DATE	DESCRIPTION		DESIGNED BY	JDW	
				CHECKED BY	PGL	
				DRAWN BY	WAC	
				CHECKED BY	PGL	- 5
				APPROVED BY	NKS	-
				I		
PLOT DATE:	12/21/202	2	5:13:32 PM	DATE	12/23/2022	

RideKC STREETCAR

These plans are nterest in bidding

ISSUED FOR BID 10450 Holmes Road Suite 600 Kansas City, MO 64131-3471 816-360-2700 Certificate of Authority: 000856

The HNTB COMPANIES INFRASTRUCTURE SOLUTIONS 300 Apollo Drive Chelmsford, MA 01824 Phone: 978-905-4000 Certificate of Authority: 001270

NOT FOR CONSTRUCTION

TRACTION POWER TYPICAL TPSS RECEPTACLES AND SMOKE DETECTOR SCHEMATIC

DATE: 12-23-2022


HNTB
The HNTB COMPANIES


TRACTION POWER

SCALE FOR 22"x34":
NOT TO SCALE
FILENAME:
J645,DWG
CONTRACT NO.: CONTRACT NO. ###
VOLUME:

J645

- FINAL SCHEMATICS, LOGIC, AND FUNCTIONAL REQUIREMENTS SHALL BE DEVELOPED BY THE VENDOR. SEE SHOP DRAWING SUPPLIED BY BUILDING VENDOR VIA OWNER.
- 2. EQUIPMENT SPECIFIC SCHEMATICS (AC SWITCHGEAR, DC SWITCHGEAR, RECTIFIER TRANSFORMER, RECTIFIER, ETC.) SHALL BE PROPOSED BY VENDOR. SEE SHOP DRAWINGS SUPPLIED BY BUILDING VENDOR VIA OWNER.

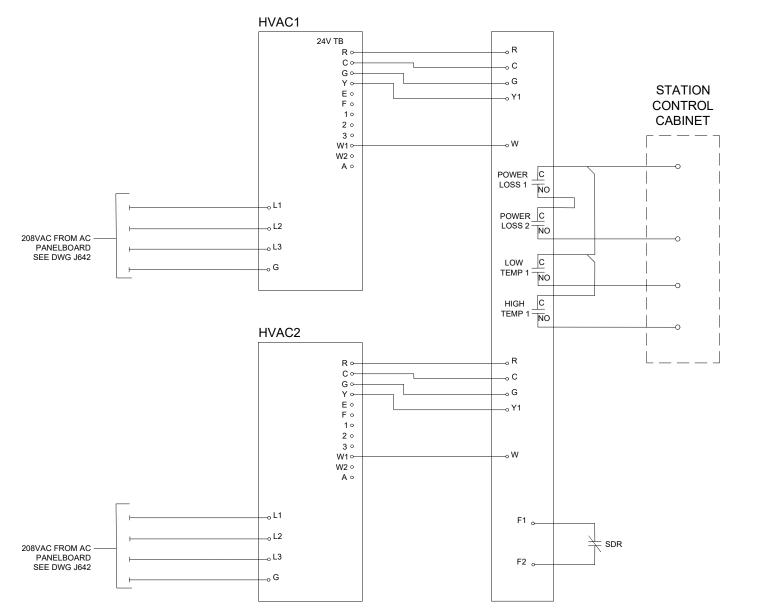

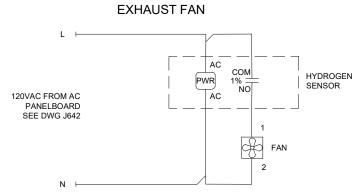

DRAWING FOR CONTRACTOR COORDINATION PURPOSES. TPSS SHALL BE OWNER SUPPLIED WHEN AVAILABLE.

Т	JDW	DESIGNED BY	TE DESCRIPTION	DATE	REV
	PGL	CHECKED BY			
: [WAC	DRAWN BY			
		1			
	PGL	CHECKED BY			
1	NKS	APPROVED BY			
,	12 /23 /2022	DATE	21/2022 5:13:46 PM	12/21/202	PLOT DATE:

RideKC STREETCAR

ISSUED FOR BID The HNTB COMPANIES INFRASTRUCTURE SOLUTIONS 300 Apollo Drive Chelmsford, MA 01824 Phone: 978-905-4000 Certificate of Authority: 001270 10450 Holmes Road Suite 600 Kansas City, MO 64131-3471 816-360-2700 Certificate of Authority: 000856

NOT FOR CONSTRUCTION

DATE: 12-23-2022

HNTB
The HNTB COMPANIES INFRASTRUCTURE SOLUTIONS 200 Apollo Drive Chelmsford, MA 0 1824

TYPICAL TPSS HVAC AND VENTILATION SCHEMATIC


TYPICAL TPSS HVAC AND VENTILATION SCHEMATIC

SCALE FOR 22"x34":
NOT TO SCALE FILENAME:
JG46.DWG
CONTRACT NO.:
CONTRACT NO.:
CONTRACT NO. ###

VOLUME:
VOLUME:


1. FOR COORDINATION ONLY. FINAL SCHEMATICS, LOGIC, AND FUNCTIONAL REQUIREMENTS SHALL BE DEVELOPED BY THE VENDOR. SEE SHOP DRAWINGS SUPPLIED BY BUILDING VENDOR VIA OWNER.

AND GATE

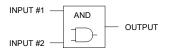


INPUT #1	INPUT #2	OUTPUT
0	0	0
0	1	0
1	0	0
1	1	1

OR GATE

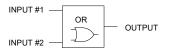

INPUT #1	INPUT #2	OUTPUT
0	0	0
0	1	1
1	0	1
1	1	1

EXCLUSIVE OR GATE

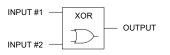


INPUT #1	INPUT #2	OUTPUT
0	0	0
0	1	1
1	0	1
1	1	0

SIGNAL INVERSION

INPUT ──○ OUTPUT ___ ОИТРИТ

INPUT	OUTPUT
0	1
1	0


SET OVER RESET **OPERATOR**

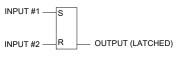

INPUT #1	INPUT #2	OUTPUT (LATCHED)
0	0	PREVIOUS STATE
0	1	0
1	0	1
1	1	PREVIOUS STATE


OUTPUT CHANGES STATE ONLY UPON RISING EDGE OF INPUT SIGNAL

TIME DELAY

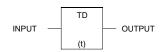


A RISING EDGE ON THE INPUT STARTS THE TIMER(t). THE TIMER COUNTS AS LONG AS THE INPUT IS HIGH. IF THE TIMER EXPIRES WHILE THE INPUT IS HIGH THE OUTPUT BECOMES ACTIVE. A FALLING INPUT EDGE RESETS THE TIMER.

GREATER THAN COMPARATOR

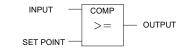


IF THE INPUT VALUE IS GREATER THAN OR EQUAL TO THE SET POINT, THE OUTPUT BECOMES ACTIVE.

LESS THAN **COMPARATOR**

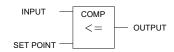

IF THE INPUT VALUE IS LESS THAN OR EQUAL TO THE SET POINT, THE OUTPUT BECOMES ACTIVE.

COUNTER

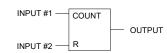

EACH TIME INPUT #1 IS PULSED HIGH THE COUNTER INCREMENTS AND THE OUTPUT REFLECTS THE COUNT VALUE. WHEN INPUT #2 IS PULSED HIGH THE COUNT VALUE IS RESET

> DRAWING FOR CONTRACTOR COORDINATION PURPOSES. TPSS SHALL BE OWNER SUPPLIED WHEN AVAILABLE.

REV DATE DESCRIPTION DESIGNED BY HECKED BY CHECKED BY APPROVED BY PLOT DATE: 12/21/2022 5:14:00 PM DATE



not for These plans are interest in bidding



Chelmsford, MA 01824 Phone: 978-905-4000 Certificate of Authority: 001270

NOT FOR CONSTRUCTION

TRACTION POWER

LOGIC DIAGRAMS SYMBOLS AND LEGEND

DATE: 12-23-2022 KANSAS CITY STREETCAR - RIVERFRONT EXTENSION SCALE FOR 22"x34" NOT TO SCALE FILENAME: J648.DWG CONTRACT NO.: CONTRACT NO. ###
VOLUME: DRAWING NO.:

J648

SUBSTATION LOCKOUT AND ALARM LOGIC SAS PLC 1. PLC OUTPUT ACTIVATES LOCKOUT RELAY 186 & 86X. 2. THIS SIGNAL IS ACTIVE LOW. OR FLASHING BLUE LIGHT (NEW UNACKNOWLEDGED ALARM) SOLID BLUE LIGHT (ACTIVE ACKNOWLEDGED ALARMS) (33T) TPT DOOR OPEN DC LOCK OUT 186 BLUE LIGHT OFF (NO ACTIVE ALARMS). (33N, 33P, 33R) NEG, POS, RECT CUB DOOR OPEN FOR COORDINATION ONLY. FINAL SCHEMATICS, LOGIC, AND FUNCTIONAL REQUIREMENTS SHALL BE DEVELOPED BY THE VENDOR. SEE SHOP DRAWINGS SUPPLIED BY BUILDING VENDOR VIA OWNER. (49T2) TRANSFORMER WINDING TEMPERATURE TRIP (26-RT2) RECTIFIER TEMP. TRIP (98-2) RECTIFIER DIODE FAILURE (148) CIRCUIT BREAKER INCOMPLETE SEQUENCE RECTIFIER OVER/UNDER VOLTAGE VALUE COMP DRAWING FOR CONTRACTOR COORDINATION RECTIFIER OVER/UNDER VOLTAGE TRIP SET POINT PURPOSES. TPSS SHALL BE OWNER SUPPLIED ACTUAL CURRENT VALUE COMP WHEN AVAILABLE. (32) REVERSE CURRENT THRESHOLD (ETS) EMERGENCY TRIP STATION (64HS) DC SWGR FRAME "ALIVE" FIRE/SMOKE ALARM AC LOCK OUT 86X PLC FAIL OR STATION TROUBLE BLUE SUBSTATION ALARM INPUTS LAMP (NOTE 3) (SEE SCADA INTERFACE POINTS TABLE IN SPECIFICATIONS) STATION TROUBLE RESET BUTTON LOCAL / REMOTE LOGIC AC SWGR SAS PLC DC SGWR (AC SWGR 43) SYSTEM IN LOCAL TO BREAKER LOGIC SYSTEM IN LOCAL LAMP (AC SWGR 43) SYSTEM IN REMOTE TO BREAKER LOGIC SYSTEM IN REMOTE LAMP DATE: 12-23-2022 KANSAS CITY STREETCAR - RIVERFRONT EXTENSION SCALE FOR 22"x34" NOT TO SCALE FILENAME: DESCRIPTION DESIGNED B DATE SSUED FOR BID HECKED BY J649.DWG CONTRACT NO.: **R**ideKC TRACTION POWER CONTRACT NO. ### VOLUME: 10450 Holmes Road Suite 600 Kansas City, MO 64131-3471 These plans are **STREETCAR** SUBSTATION LOCKOUT AND ALARM LOGIC DIAGRAM CHECKED BY Chelmsford, MA 01824 Phone: 978-905-4000 APPROVED B 816-360-2700 Certificate of Authority: 000856 Certificate of Authority: 001270 J649 150 5:14:24 PM DATE NOT FOR CONSTRUCTION PLOT DATE: 12/21/2022 302982

- 1. WHEN CONDITIONS ARE MET OUTPUT IS PULSED ONCE.
- 2. WHEN THE BREAKER IS CLOSED THIS OUTPUT IS SET HIGH.
- THE BREAKER OPEN OUTPUT LATCH IS SET WHEN ALL CONDITIONS ARE SATISFIED FOR BREAKER CLOSE AND IT IS RESET WHEN CONDITIONS ARE SATISFIED FOR BREAKER OPEN
- 4. BREAKER GROUP ALARM IS A SUMMARY ALARM. AVAILABILITY OF THIS ALARM VARIES BY MFPR MANUFACTURER.
- 5. FOR COORDINATION ONLY. FINAL SCHEMATICS, LOGIC, AND FUNCTIONAL REQUIREMENTS SHALL BE DEVELOPED BY THE VENDOR. SEE SHOP



AC MAIN BREAKER TO TRANSFORMER TRIPPING LOGIC

OR

AND

(27)

COMP

MAXIMUM

VOLTAGE

MAXIMUM

VOLTAGE


SET POINT

DRAWING FOR CONTRACTOR COORDINATION PURPOSES. TPSS SHALL BE OWNER SUPPLIED WHEN AVAILABLE.

BREAKER OPEN LIGHT NOTE 4 BREAKER GROUP ALARM LIGHT

AC MAIN BREAKER TO TRANSFORMER CLOSE LOGIC

TO SYSTEM LOGIC

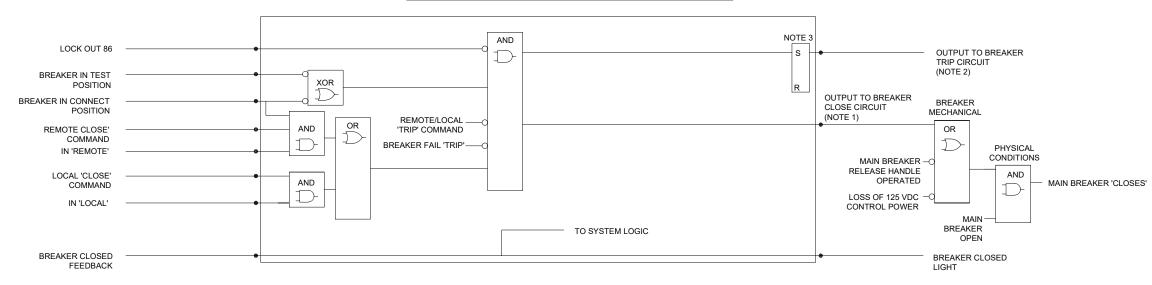

REV	DATE	DESCRIPTION		DESIGNED BY	JDW	
				CHECKED BY	PGL	
				DRAWN BY	JDW	
				1		
				CHECKED BY	PGL	 >
				APPROVED BY	NKS	ļ -
PLOT DATE:	12/21/202	22	5:14:43 PM	DATE	12/23/2022	

LOCAL 'OPEN'

'OPEN' COMMAND

ACTUAL VOLTAGE

LOCK OUT 86

BREAKER OPENED

VALUE

COMMAND

REMOTE

RideKC **STREETCAR**

These plans are tended to build terest in bidding

SSUED FOR BID 10450 Holmes Road Suite 600 Kansas City, MO 64131-3471 816-360-2700 Certificate of Authority: 000856

NOT FOR CONSTRUCTION


Chelmsford, MA 01824 Phone: 978-905-4000

Certificate of Authority: 001270

TRACTION POWER **AC SWITCHGEAR** INCOMING CUBICLE LOGIC DIAGRAM

DATE: 12-23-2022 KANSAS CITY STREETCAR - RIVERFRONT EXTENSION SCALE FOR 22"x34" NOT TO SCALE FILENAME: J650.DWG CONTRACT NO.: CONTRACT NO. ###
VOLUME: DRAWING NO.: J650 151

- WHEN THE BREAKER IS CLOSED THIS OUTPUT IS SET HIGH
- THE BREAKER OPEN OUTPUT LATCH IS SET WHEN ALL CONDITIONS ARE SATISFIED FOR BREAKER CLOSE AND IT IS RESET WHEN CONDITIONS ARE SATISFIED FOR BREAKER OPEN.
- BREAKER GROUP ALARM IS A SUMMARY ALARM. AVAILABILITY OF THIS ALARM VARIES BY MFPR MANUFACTURER.

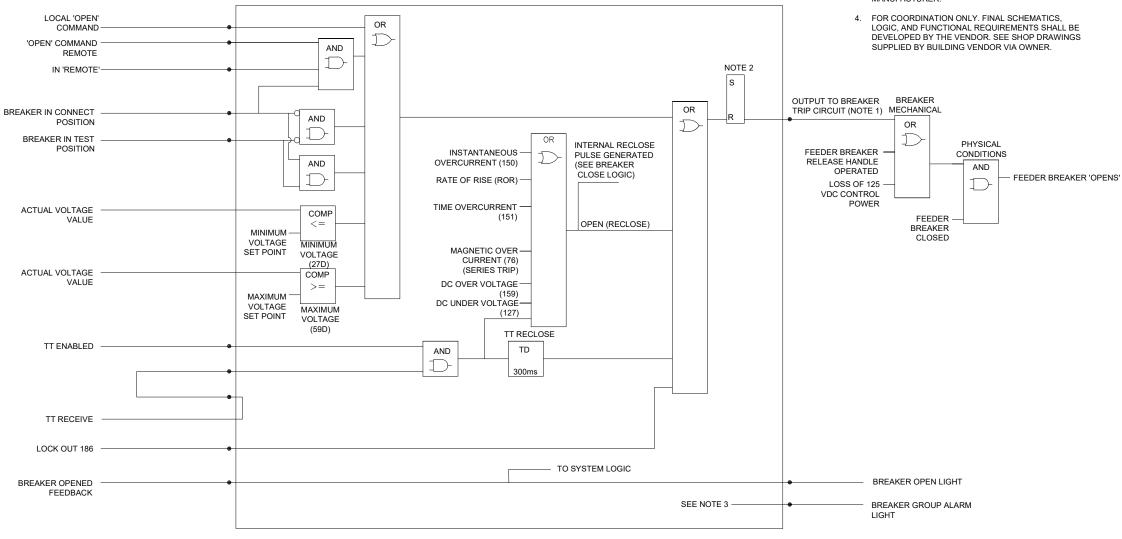

DC FEEDER BREAKER 'TRIPPING' OPERATION

DRAWING FOR CONTRACTOR COORDINATION PURPOSES. TPSS SHALL BE OWNER SUPPLIED WHEN AVAILABLE.

RideKC STREETCAR

This set of plans is not for construction.
These plans are intended to build interest in bidding the project.

HDR Engineering, Inc.

10450 Holmes Road
Suite 600
Kansas City, Mo 64131-3471
816-380-2700
Certificate of Authority 000856

NOT FOR CONSTRUCTION

HNTB
The HNTB COMPANIES
INFRASTRUCTURE SOLUTIONS
300 Apollo Drive
Chelmsford, MA 01824
Phone: 978-905-4000
Certificate of Authority: 001270

DATE: 12-23-2022
HNTB

KANSAS CITY STREETCAR - RIVERFRONT EXTENSION | SCALE FOR 22"x34"
NOT TO SCALE
FILENAME:

TRACTION POWER
TYPICAL DC FEEDER CUBICLE
LOGIC DIAGRAM SHEET 1 OF 2

SCALE FOR 22"x34":
NOT TO SCALE
FILENAME:
J652.DWG
CONTRACT NO.:
CONTRACT NO. ###
VOLUME:
1
DRAWING NO.: SHEET NO.:
J652
152

NOTES: 1. WHEN CONDITIONS ARE MET OUTPUT IS PULSED ONCE. 2. WHEN THE BREAKER IS CLOSED THIS OUTPUT IS SET HIGH. THE BREAKER OPEN OUTPUT LATCH IS SET WHEN ALL CONDITIONS ARE SATISFIED FOR BREAKER CLOSE AND IT IS RESET WHEN CONDITIONS ARE SATISFIED FOR BREAKER OPEN. DC FEEDER BREAKER 'CLOSING' OPERATION 4. THERE ARE 3 TEST PAUSE TIMERS. THE TIME USED DEPENDS ON THE CURRENT TEST CYCLE COUNT. IN THE EVENT THAT THE NUMBER OF TEST CYCLES IS SET GREATER THAN THREE AFTER THE THIRD TEST CYCLE THE SAME TIME IS USED. 5. ALL TIMER DURATIONS ARE PROGRAMMABLE VIA THE FRONT DISPLAY. LOCK OUT 86 FOR COORDINATION ONLY. FINAL SCHEMATICS, LOGIC, AND FUNCTIONAL REQUIREMENTS SHALL BE DEVELOPED BY THE VENDOR. SEE SHOP DRAWINGS SUPPLIED BY BUILDING VENDOR VIA OWNER. BREAKER IN TEST XOR POSITION NOTE 3 OUTPUT TO BREAKER BREAKER IN CONNECT TRIP CIRCUIT POSITION AND OR REMOTE 'CLOSE' COMMAND IN 'REMOTE' AND INTERNAL FROM BREAKER \Box RECLOSE RE-CLOSE PULSE LOGIC LOCAL 'CLOSE' AND COMMAND IN 'LOCAL' SHORT TEST-ENABLED COMP ACTUAL VOLTAGE VALUE PRE-PAUSE SHORT TEST VOLTAGE TD AND SET POINT OUTPUT TO LINE TEST CONTACTOR LINE TEST (t) DISABLED COMP AND OR SHORT TEST-SET POINT SHORT TEST TEST PAUSE DISABLED (NOTE 4) OUTPUT TO BREAKER REMOTE/LOCAL BREAKER MECHANICAL CLOSE CIRCUIT TD COMP 'TRIP' COMMAND OR (NOTE 1) AND TRANSFER 'TRIP' LINE TEST RECEIVED VOLTAGE PHYSICAL CONDITIONS SET POINT TEST CONTRACTOR FEEDER BREAKER BREAKER FAIL 'TRIP' CLOSED RELEASE HANDLE AND FEEDER TD OPERATED BREAKER LINE TEST COUNT LOSS OF 125 VDC-'CLOSES' CONTRACTOR CONTROL POWER COMP CLOSED >= BREAKER OPEN CONTINUOUS TEST CYCLE SHORT CIRCUIT SET POINT AND TERMINATE AND CHECKING COMP DRAWING FOR CONTRACTOR COORDINATION LINE TEST-PURPOSES. TPSS SHALL BE OWNER SUPPLIED VOLTAGE AND SET POINT WHEN AVAILABLE. BREAKER DIRECT CLOSE TO SYSTEM LOGIC BREAKER CLOSED BREAKER CLOSED FEEDBACK LIGHT DATE: 12-23-2022 KANSAS CITY STREETCAR - RIVERFRONT EXTENSION SCALE FOR 22"x34" NOT TO SCALE FILENAME: SSUED FOR BID

REV	DATE	DESCRIPTION		DESIGNED BY	JDW	
				7		
				CHECKED BY	PGL	
				DRAWN BY	JDW	
				CHECKED BY	PGL	
						_
				APPROVED BY	NKS	
PLOT DATE:	12/21/202	2	5:15:07 PM	DATE	12/23/2022	

RideKC STREETCAR

This set of plans is not for construction.
These plans are intended to build interest in bidding the project.

HDR Engineering, Inc.

10450 Holmes Road
Suite 600
Kansas City, MO 64131-3471
816-380-2700
Certificate of Authority 000856

NOT FOR CONSTRUCTION

The HNTB COMPANIES
INFRASTRUCTURE SOLUTIONS
300 Apollo Drive
Chelmsford, MA 01824
Phone: 978-905-4000


Certificate of Authority: 001270

TRACTION POWER
TYPICAL DC FEEDER CUBICLE
LOGIC DIAGRAM SHEET 2 OF 2


SCALE FOR 22"x34":
NOT TO SCALE
FILENAME:
J653.DWG
CONTRACT NO.:
CONTRACT NO. ###
VOLUME:
1
DRAWING NO.: | SHEET NO.:

 FOR COORDINATION ONLY. FINAL SCHEMATICS, LOGIC, AND FUNCTIONAL REQUIREMENTS SHALL BE DEVELOPED BY THE VENDOR. SEE SHOP DRAWINGS SUPPLIED BY BUILDING VENDOR VIA OWNER.

NEGATIVE DISCONNECT SWITCH LOGIC

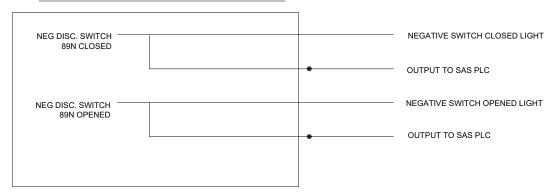

POSITIVE DISCONNECT SWITCH LOGIC

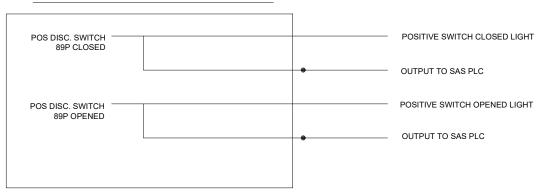

DRAWING FOR CONTRACTOR COORDINATION PURPOSES. TPSS SHALL BE OWNER SUPPLIED WHEN AVAILABLE.

DΑ	TE	DESCRIPTION		DESIGNED BY	JDW	
				CHECKED BY	PGL	
				DRAWN BY	WAC	ı
				CHECKED BY	PGL	
				APPROVED BY	NKS	
12/2	1/202	5:15	:30 PM	DATE	10 /07 /0000	



This set of plans is not for construction.
These plans are intended to build interest in bidding the project.



DATE: 12-23-2022

HNTB

The HITE COMPANES
INFRASTRUCTURE SOLUTIONS
300 Apollo Drive
Chelmisdrd, MA 01824
Phone: 979-90544000
Certificate of Authority: 001270

NOT FOR CONSTRUCTION

DATE: 12-23-2022


HNTB
The HINTB COMPANIES
INFRASTRICITIES SOLUTIONS
TRACTION POWER


SCALE FOR 22"x34":
NOT TO SCALE
FILENAME:
J654.DWG
CONTRACT NO:

TRACTION POWER
NEGATIVE AND POSITIVE DISCONNECT SWITCH
LOGIC DIAGRAM

SCALE FOR 22"x34":
NOT TO SCALE
FILENAME:
JOSS4.DWG
CONTRACT NO.:
CONTRACT NO. ###
VOLUME:
1
DRAWING NO.: SHEET NO.:
J654
154

- 1. FOR COORDINATION PURPOSES.
- 2. SEE SHOP DRAWINGS SUPPLIED BY BUILDING VENDOR VIA OWNER.

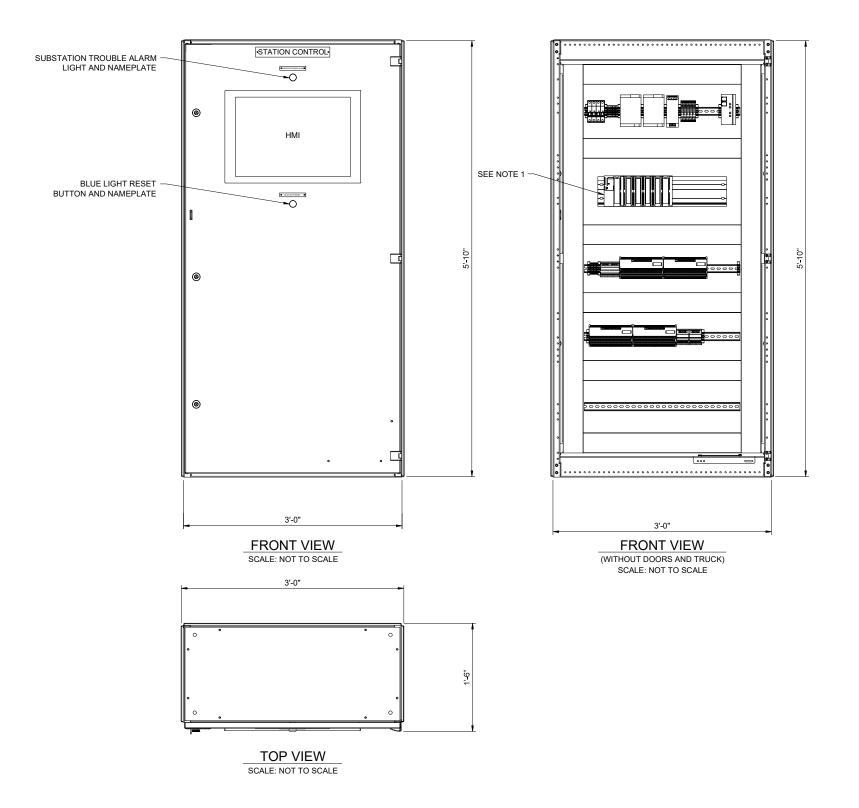

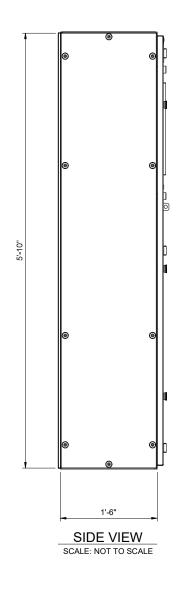

DRAWING FOR CONTRACTOR COORDINATION PURPOSES. TPSS SHALL BE OWNER SUPPLIED WHEN AVAILABLE.

REV	DATE	DESCRIPTION	DESIGNED BY	JDW
			CHECKED BY	PGL
			DRAWN BY	JDW
			-	
			CHECKED BY	PGL
			APPROVED BY	NKS
PLOT DATE:	12/21/202	2 5:15:37 PM	DATE	12 /27 /2022

RideKC STREETCAR

ISSUED FOR BID 10450 Holmes Road Suite 600 Kansas City, MO 64131-3471 816-360-2700 Certificate of Authority: 000856

The HNTB COMPANIES INFRASTRUCTURE SOLUTIONS 300 Apollo Drive Chelmsford, MA 01824 Phone: 978-905-4000 Certificate of Authority: 001270

NOT FOR CONSTRUCTION


DATE: 12-23-2022

HNTB
The HNTB COMPANIES INFRASTRUCTURE SOLUTIONS 300 Apollo Drive Chelmsford, MA 01824

SCALE FOR 22"x34":
NOT TO SCALE FILENAME:
J660.DWD
CONTRACT NO:
CONTRACT NO:
CONTRACT NO. ###
VOLUME:
VOLUME

STATION CONTROL CABINET TYPICAL LAYOUT

DRAWING NO.: J660 155

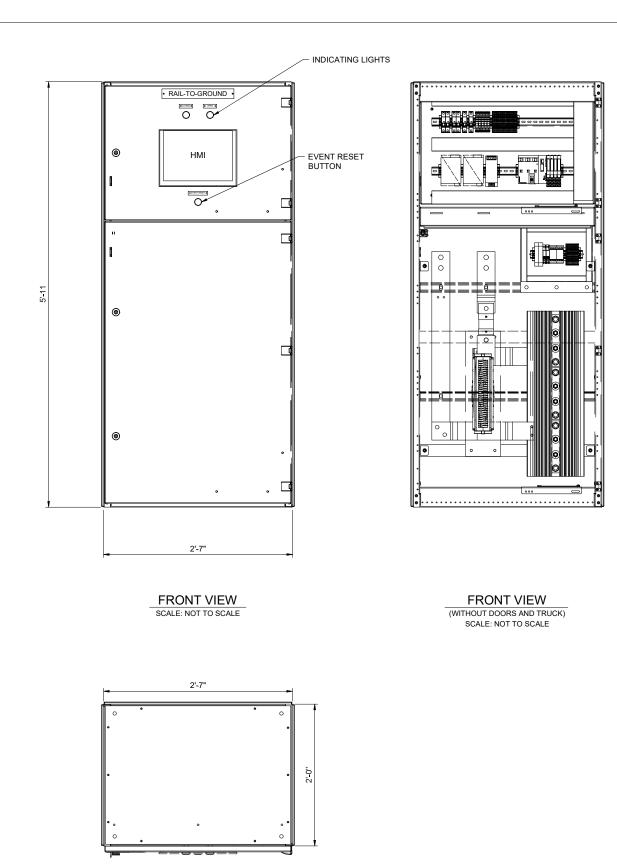

- 1. FOR COORDINATION PURPOSES.
- 2. SEE SHOP DRAWINGS SUPPLIED BY BUILDING VENDOR VIA OWNER.

DRAWING FOR CONTRACTOR COORDINATION PURPOSES. TPSS SHALL BE OWNER SUPPLIED WHEN AVAILABLE.

REV DATE DESCRIPTION DESIGNED BY CHECKED BY CHECKED BY APPROVED BY 5:15:55 PM DATE PLOT DATE: 12/21/2022

TOP VIEW

SCALE: NOT TO SCALE



This set of plans is These plans are ntended to build



NOT FOR CONSTRUCTION

HNTB The HNTB COMPANIES INFRASTRUCTURE SOLUTIONS 300 Apollo Drive Chelmsford, MA 01824 Phone: 978-905-4000 Certificate of Authority: 001270

2'-0"

SIDE VIEW


SCALE: NOT TO SCALE

TRACTION POWER RAIL-TO-GROUND (R2G) CABINET TYPICAL LAYOUT

DATE: 12-23-2022
HNTB

KANSAS CITY STREETCAR - RIVERFRONT EXTENSION | SCALE FOR 22"x34": NOT TO SCALE FILENAME: J661.DWG CONTRACT NO.: CONTRACT NO. ###
VOLUME: DRAWING NO.:

J661

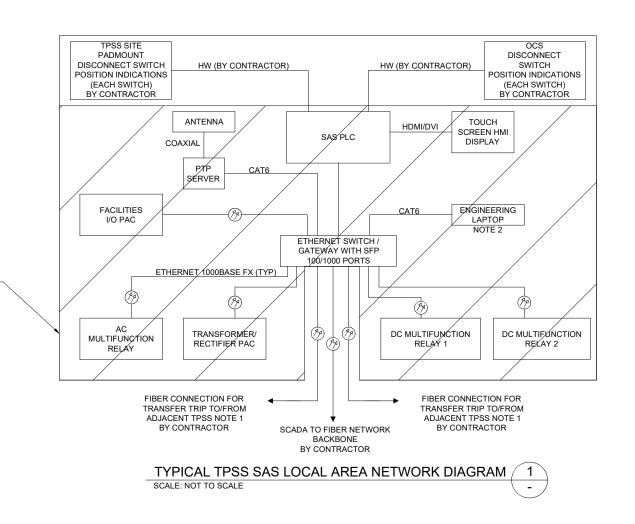

SAS EQUIPMENT WITHIN TPSS BUILDING -BY VENDOR (FURNISHED BY OWNER)

IS PROVIDED UNDER THIS CONTRACT.

DESIGNED B'

HECKED BY

DRAWN BY

CHECKED BY

APPROVED B

5:16:19 PM DATE

RideKC

STREETCAR

SHOWN FOR COORDINATION PURPOSES, SEE NOTE 3. EXTERNAL INTERFACES BY CONTRACTOR.

PROGRAMMING, TESTING, AND COMMISSIONING BY CONTRACTOR. CONTRACT MUST ENSURE A COMPLETE, FUNCTIONAL SYSTEM

DATE DESCRIPTION

PLOT DATE: 12/21/2022

NOTES:


- CONTRACTOR SHALL CONFIGURE TRANSFER TRIP FUNCTION BETWEEN ADJACENT TPSS DC MULTIFUNCTION RELAYS USING THE COMMUNICATIONS SYSTEM FOR FIBER OPTIC CONNECTION. SEE SPECIFICATIONS FOR ADDITIONAL DETAILS.
- PROVIDE ONE ENGINEERING LAPTOP PER THE SPECIFICATIONS (BY BUILDING VENDOR).

DATE: 12-23-2022 KANSAS CITY STREETCAR - RIVERFRONT EXTENSION SCALE FOR 22"x34": NOT TO SCALE FILENAME:

TRACTION POWER

TPSS COMMUNICATIONS BLOCK DIAGRAM

3. SHOP DRAWINGS SHALL BE PROVIDED BY THE BUILDING VENDOR VIA OWNER WHEN AVAILABLE.

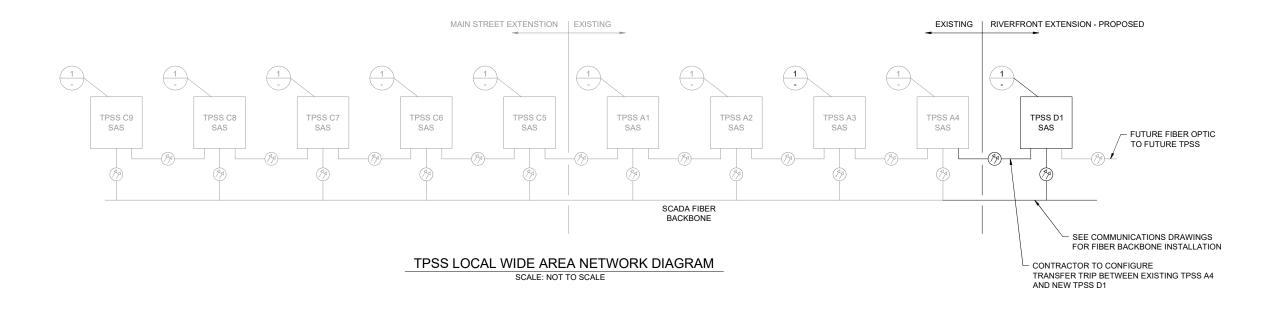

NOT FOR CONSTRUCTION

Chelmsford, MA 01824

Certificate of Authority: 001270

Phone: 978-905-4000

SSUED FOR BID

10450 Holmes Road Suite 600

816-360-2700

Kansas City, MO 64131-3471

Certificate of Authority: 000856

This set of plans is not for

These plans are

tended to build

nterest in bidding


157

J665.DWG CONTRACT NO.:


DRAWING NO.:

J665


CONTRACT NO. ###
VOLUME:

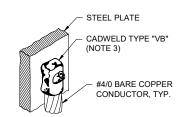




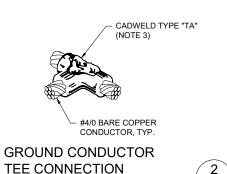

SCALE: NOT TO SCALE

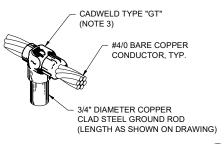



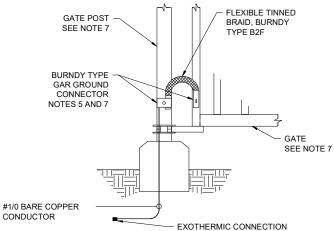


GATE GROUNDING CONNECTION

SCALE: NOT TO SCALE


6

- 1. GROUND CONDUCTOR "TEE" CONNECTIONS SHALL BE USED AT ALL GROUND GRID INTERSECTIONS AROUND THE PERIMETER OF THE GROUND GRID.
- 2. GROUND CONDUCTOR "CROSS" CONNECTIONS SHALL BE USED AT ALL GROUND GRID INTERSECTIONS WITHIN THE PERIMETER OF THE GROUND GRID.
- CADWELD TYPE CONNECTIONS LISTED FOR REFERENCE ONLY AND DOES NOT PRECLUDE ANY OTHER
- 4. DRILL AND TAP FOR 2-HOLE NEMA LUGS.
- COMPRESSION TYPE GROUND CONNECTIONS ARE ACCEPTABLE WHERE NOT IN CONTACT WITH GROUND/EARTH, BURNDY OR APPROVED EQUAL.
- 6. PRE-DRILL COPPER BUSBAR FOR NEMA 2 HOLE LUGS.
- 7. FOR VINYL COATED FENCING, REMOVE COATING AND CLEAN SURFACE PRIOR TO MAKING GROUNDING CONNECTIONS. AFTER MAKING CONNECTIONS, COAT EXPOSED FENCE POST SURFACE AND CONNECTIONS WITH A ZINC RICH PAINT.

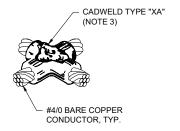


GROUND CONDUCTOR CROSS CONNECTION SCALE: NOT TO SCALE


SCALE: NOT TO SCALE

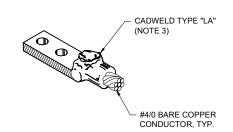


GROUND CONDUCTOR TO 2-HOLE TERMINAL CONNECTION / 5 SCALE: NOT TO SCALE

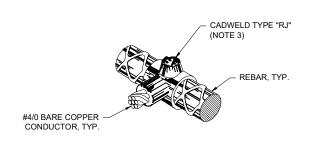


GROUND CONDUCTOR TO REBAR CONNECTION SCALE: NOT TO SCALE

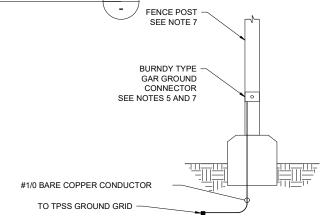


FENCE POST GROUNDING CONNECTION SCALE: NOT TO SCALE

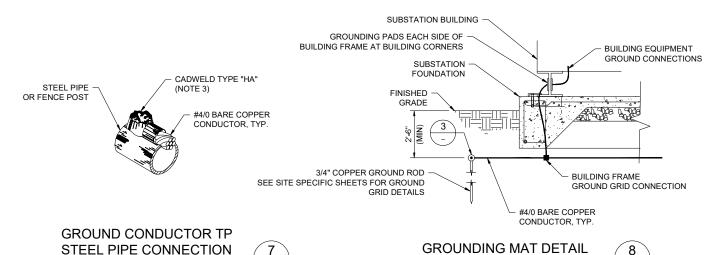

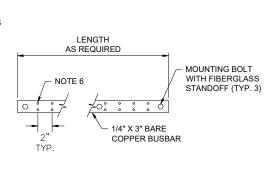

NOT FOR CONSTRUCTION

TYPICAL GROUND BUSBAR SCALE: NOT TO SCALE

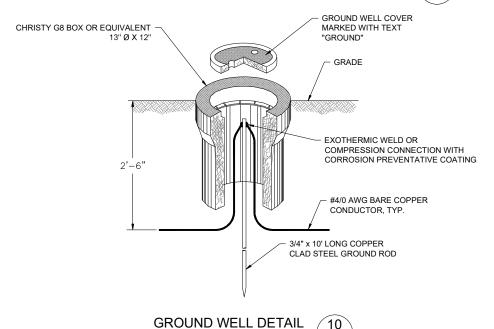

REV	DATE	DESCRIPTION	DESIGNED BY	JDW	
			CHECKED BY	PGL	
			DRAWN BY	JDW	
			1		
			CHECKED BY	PGL	
			APPROVED BY	NKS	
PLOT DATE:	12/21/202	2 5:16:53 PM	DATE	12/23/2022	



SCALE: NOT TO SCALE

These plans are tended to build nterest in bidding

ISSUED FOR BID
L
HDR Engineering, Inc.
10450 Holmes Road
Suite 600
Kansas City, MO 64131-3471
816-360-2700
Certificate of Authority: 000856

DATE: 12-23-2022 KANSAS CITY STREETCAR - RIVERFRONT EXTENSION Chelmsford, MA 01824 Phone: 978-905-4000

Certificate of Authority: 001270

TRACTION POWER TYPICAL GROUNDING DETAILS

SCALE: NOT TO SCALE

NOT TO SCALE J673.DWG CONTRACT NO.: CONTRACT NO. ### VOLUME: J673 158

1. SEE SHEET J630 FOR TPSS D1 SITE RACEWAY LAYOUT.

					TPSS D1 - CONDU	CTOR SCHEDULE					
FEEDER NUMBER	FROM	то	VIA DUCTBANK/CONDUIT DUCTBANK SECTION CABLE DESCRIPTION						DRAWING NUMBER	COMMENTS	
I LEBER NOMBER	TROW	10	VIA DOCTBANICONDOTT	DOCTBANK SECTION	QUANTITY	SIZE	TYPE	VOLTAGE RATING	TEMPERATURE RATING		COMMENTS
D1-PF1	D1-F1	D1-DS1	TPD-D1P1	2A / C404	2	250 KCMIL	EPR	2000 V	90° C	J630	POSITIVE FEEDER
	D1-DS1	TE-MH-D101	TPD-D1P5	2A / C404 10A / C404	2	250 KCMIL	EPR	2000 V	90° C	J630	
	TE-MH-D101	OCS FEEDER POLE R/34 (SB)			2	250 KCMIL	EPR	2000 V	90° C		SEE SYSTEMWID ELECTRICAL PLA
D1-PF2	D1-F1	D1-DS2	TPD-D1P2	2A / C404	2	250 KCMIL	EPR	2000 V	90° C	J630	POSITIVE FEEDE
	D1-DS2	TE-MH-D101	TPD-D1P6	2A / C404 10A / C404	2	250 KCMIL	EPR	2000 V	90° C	J630	
	TE-MH-D101	OCS FEEDER POLE R/33 (NB)			2	250 KCMIL	EPR	2000 V	90° C		SEE SYSTEMWID ELECTRICAL PLA
D1-PF3	D1-F2	D1-DS3	TPD-D1P3	2A / C404	2	250 KCMIL	EPR	2000 V	90° C	J630	POSITIVE FEEDE
	D1-DS3	TE-MH-D101	TPD-D1P7	2A / C404 10A / C404	2	250 KCMIL	EPR	2000 V	90° C	J630	
	TE-MH-D101	OCS FEEDER POLE R/34 (SB)			2	250 KCMIL	EPR	2000 V	90° C		SEE SYSTEMWII ELECTRICAL PLA
D1-PF4	D1-F2	D1-DS4	TPD-D1P4	2A / C404	2	250 KCMIL	EPR	2000 V	90° C	J630	POSITIVE FEED
	D1-DS4	TE-MH-D101	TPD-D1P8	2A / C404 10A / C404	2	250 KCMIL	EPR	2000 V	90° C	J630	
	TE-MH-D101	OCS FEEDER POLE R/33 (NB)			2	250 KCMIL	EPR	2000 V	90° C		SEE SYSTEMWII ELECTRICAL PL
D1-NR1	DC NEGATIVE BUS	TE-MH-D102	TPD-D1N1	4A / C404	4	250 KCMIL	EPR	2000 V	90° C	J630	NEGATIVE RETU
	TE-MH-D102	TRACK BLOCKOUT (SB)			4	250 KCMIL	EPR	2000 V	90° C		SEE SYSTEMWI ELECTRICAL PL
D1-NR2	DC NEGATIVE BUS	TE-MH-D102	TPD-D1N1	4A / C404	4	250 KCMIL	EPR	2000 V	90° C	J630	NEGATIVE RETU
	TE-MH-D102	TRACK BLOCKOUT (NB)			4	250 KCMIL	EPR	2000 V	90° C		SEE SYSTEMWI ELECTRICAL PL
D1-HV1	FUSED LOAD BREAK FUSED /METERING CABINET	LOCAL UTILITY SECTIONALIZER SWITCHGEAR	TPD-D1U1	2A / C404	BY LOCAL UTILITY	BY LOCAL UTILITY	BY LOCAL UTILITY	BY LOCAL UTILITY	BY LOCAL UTILITY	J630	COORDINATE CABL DUCTBANK REQUIREMENTS V LOCAL UTILITY
D1-HV2	LOCAL UTILITY SECTIONALIZER SWITCHGEAR	LOCAL UTILITY MANHOLE / SPLICE	TPD-D1U2	2A / C404	BY LOCAL UTILITY	BY LOCAL UTILITY	BY LOCAL UTILITY	BY LOCAL UTILITY	BY LOCAL UTILITY	J630	COORDINATE CABL DUCTBANK REQUIREMENTS I LOCAL UTILIT
D1-SS1	HMI PAC I/O MODULE	D1-DS1, D1-DS2, D1-DS3, D1-DS4, D1-DS5, D1-DS6 OPEN/CLOSE AUX CONTACTS	TPD-D1S1	2B / C404	2	12/C - #12 AWG	XLPE	600 V	90° C	J630	SWITCH STAT
FIBER	COMMUNICATIONS RACK	FIBER BACKBONE SEE COMMUNICATIONS PLANS	TPD-D1C1	2B / C404 4C / C404	SEE COMMUNICATIONS PLANS	SEE COMMUNICATIONS PLANS	SEE COMMUNICATIONS PLANS	SEE COMMUNICATIONS PLANS	SEE COMMUNICATIONS PLANS	SEE COMMUNICATIONS PLANS	SEE COMMUNICA PLANS

REV	DATE	DESCRIPTION	DESIGNE	ED BY	JDW
			CHECKE	D BY	PGL
			DRAWN	BY	JDW
			CHECKE	D BY	PGL
			APPRO\	/ED BY	NKS
PLOT DATE:	12 /21 /202	>	5:17:02 PM DATE		40 (07 (0000



not for interest in bidding

ISSUED FOR BID 10450 Holmes Road Suite 600 Kansas City, MO 64131-3471 816-360-2700 Certificate of Authority: 000856

NOT FOR CONSTRUCTION

The HNTB COMPANIES INFRASTRUCTURE SOLUTIONS 300 Apollo Drive Chelmsford, MA 01824 Phone: 978-905-4000 Certificate of Authority: 001270


DATE: 12-23-2022
HNTB
The HNTB COMPANIES INFRASTRUCTURE SOLUTIONS 300 Apollo Drive Chelmsford, MA 01824

HATS TRACTION POWER
D1 CONDUCTOR SCHEDULE

SCALE FOR 22"x34":
NOT TO SCALE FILENAME:
J680.DWG
CONTRACT NO.:
CONTRACT NO.:
CONTRACT NO. ###

D1 CONDUCTOR SCHEDULE

DRAWING NO.: SHEET NO.: J680 | 159

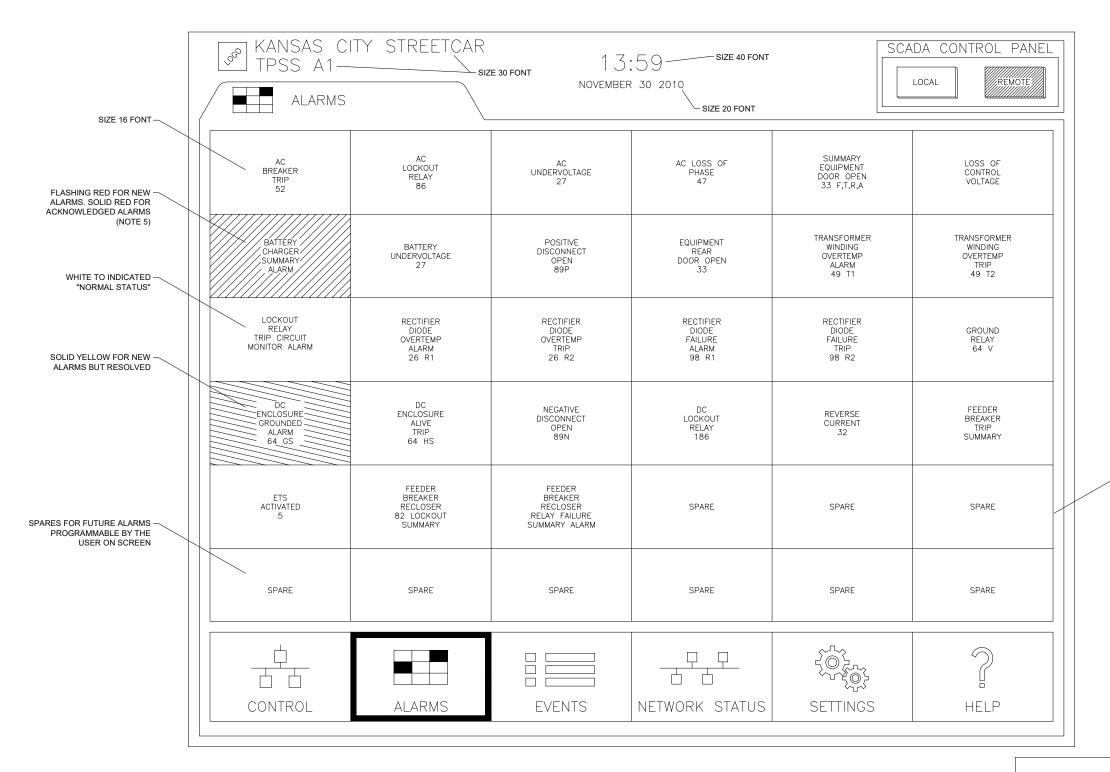

- 1. NOT USED.
- 2. HEADER INFORMATION SHALL BE VIEWABLE AT ALL TIMES.
- 3. EXTEND GUI TO FULL DIMENSIONS OF HMI SCREEN
- 4. THERE SHALL BE A MINIMUM OF 36 WINDOWS.
- 5. TOUCH WINDOW TO ACKNOWLEDGE ALARMS.

DRAWING FOR CONTRACTOR COORDINATION PURPOSES. TPSS SHALL BE OWNER SUPPLIED WHEN AVAILABLE.

REV	DATE	DESCRIPTION		DESIGNED BY	JDW	
				CHECKED BY	PGL	
				DRAWN BY	JDW	
				1		
				CHECKED BY	PGL	. 5
				APPROVED BY	NKS	1
PLOT DATE:	12/21/202	2	5:17:37 PM	DATE	12/23/2022	

RideKC **STREETCAR** This set of plans is not for These plans are interest in bidding

ISSUED FOR BID HOR 10450 Holmes Road Suite 600 Kansas City, MO 64131-3471 816-360-2700 Certificate of Authority: 000856

Chelmsford, MA 01824 Phone: 978-905-4000

NOT FOR CONSTRUCTION


Certificate of Authority: 001270


TRACTION POWER TYPICAL TPSS HMI ALARM **SCREEN LAYOUT**

- NOTE 4

DATE: 12-23-2022 KANSAS CITY STREETCAR - RIVERFRONT EXTENSION SCALE FOR 22 NOT TO SCALE FILENAME: J690-J693.DWG_ CONTRACT NO.:

CONTRACT NO. ###
VOLUME: J690

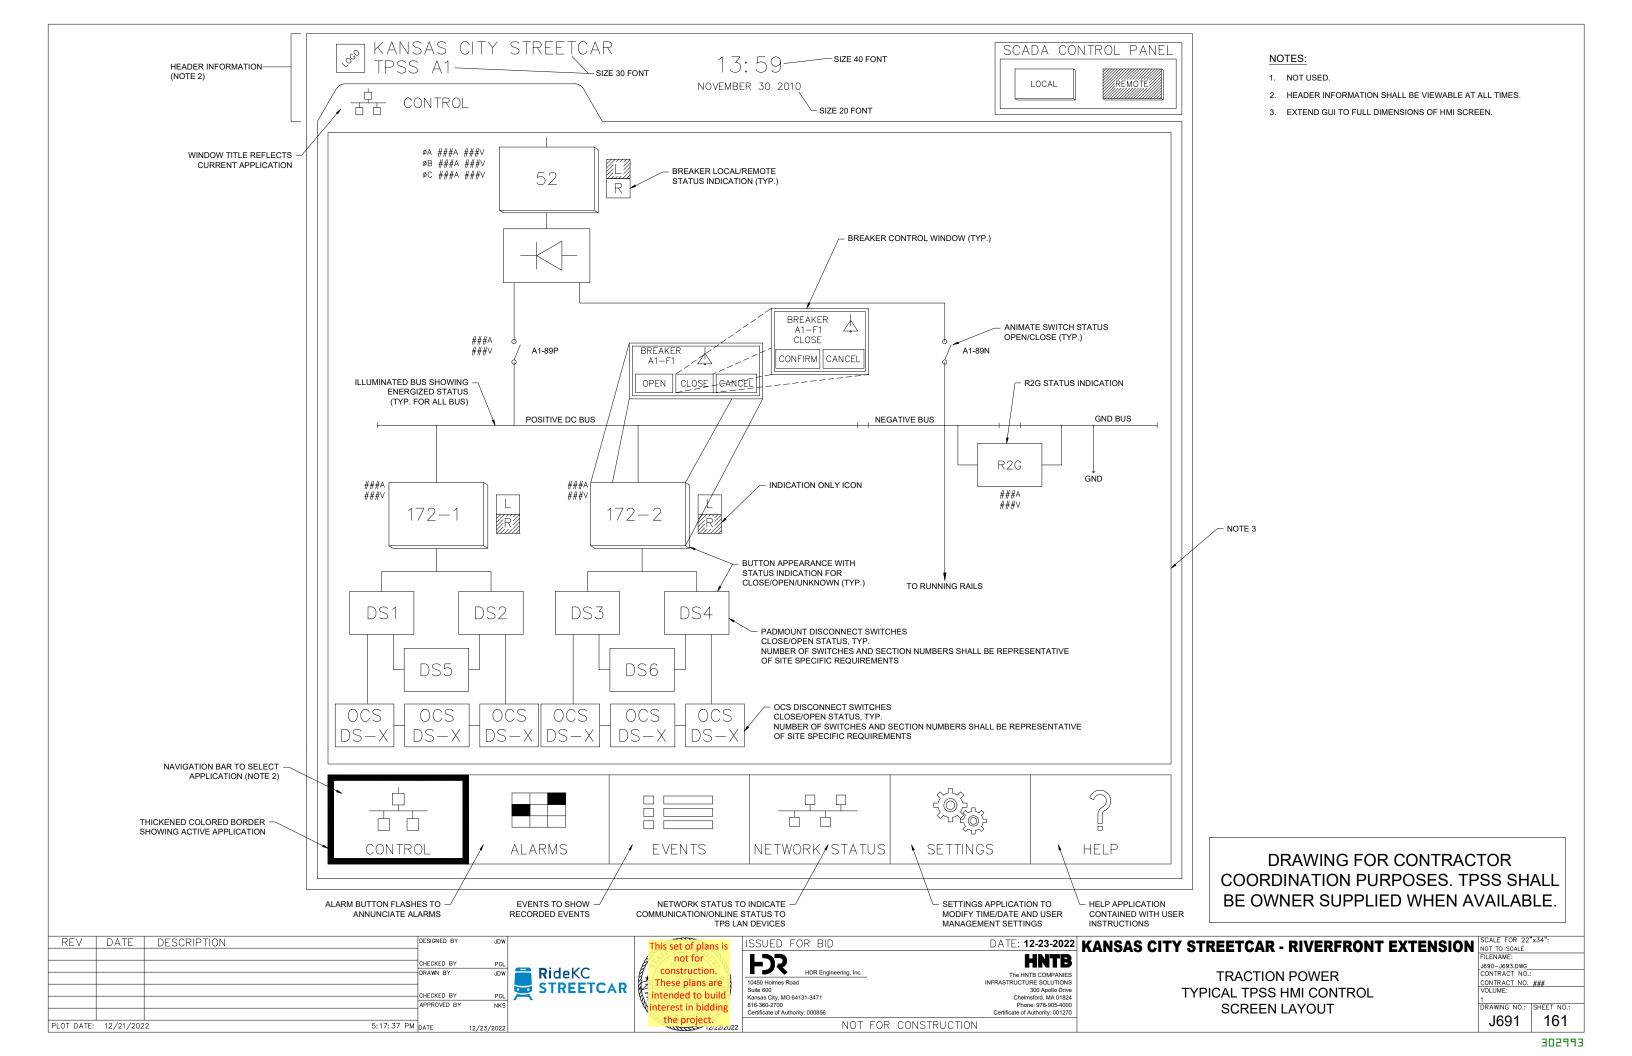

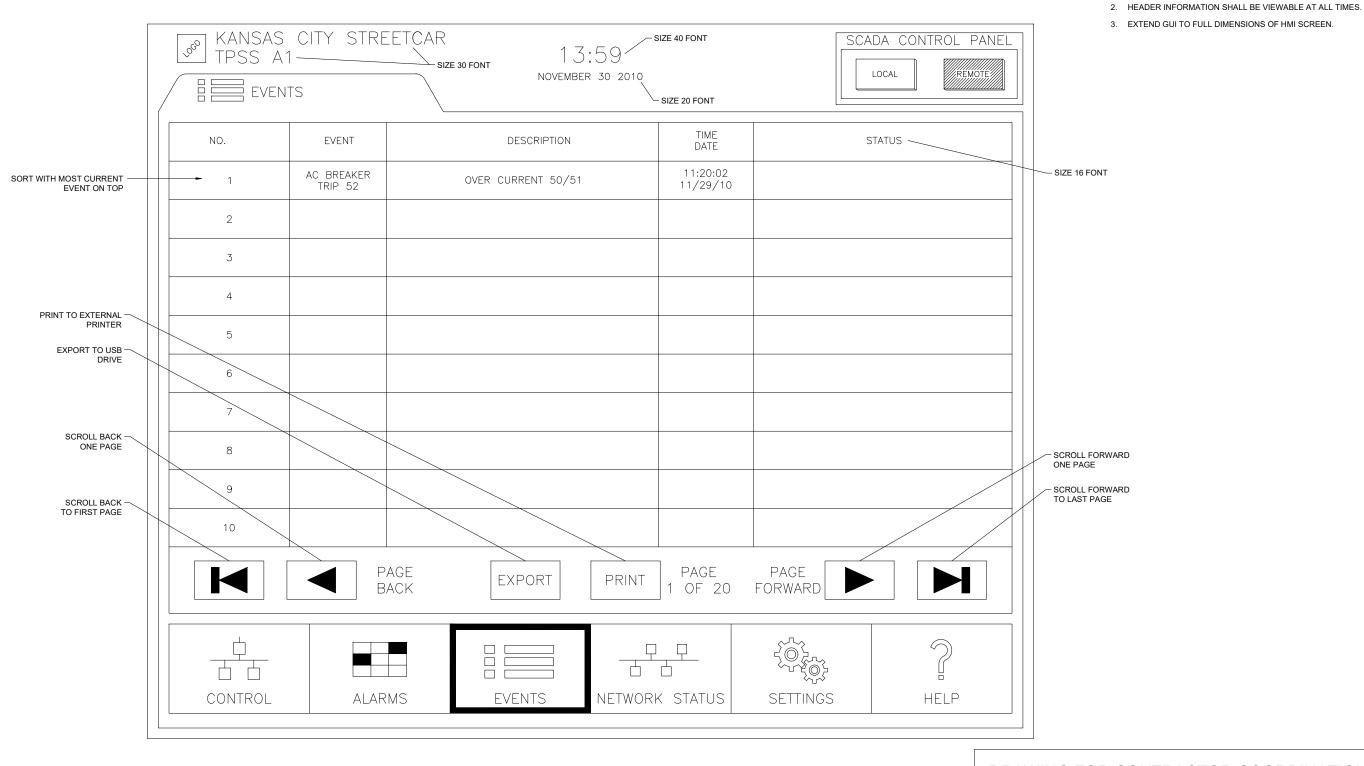

DRAWING FOR CONTRACTOR COORDINATION PURPOSES. TPSS SHALL BE OWNER SUPPLIED WHEN AVAILABLE.

REV	DATE	DESCRIPTION		DESIGNED BY	JDW	
				CHECKED BY	PGL	_
				DRAWN BY	JDW	
				-		
				CHECKED BY	PGL	⊭
				APPROVED BY	NKS	Ī
PLOT DATE:	12/21/202	2	5:17:37 PM	DATE	12/23/2022	

RideKC STREETCAR

This set of plans is not for

ISSUED FOR BID 10450 Holmes Road Suite 600 Kansas City, MO 64131-3471 816-360-2700 Certificate of Authority: 000856

NOT FOR CONSTRUCTION


300 Apollo Drive Chelmsford, MA 01824 Phone: 978-905-4000

Certificate of Authority: 001270

TRACTION POWER TYPICAL TPSS HMI EVENT LOG SCREEN LAYOUT

NOTES: NOT USED.

DATE: 12-23-2022 KANSAS CITY STREETCAR - RIVERFRONT EXTENSION SCALE FOR 22"x34": J690-J693.DWG_ CONTRACT_NO.: CONTRACT NO. ###
VOLUME:

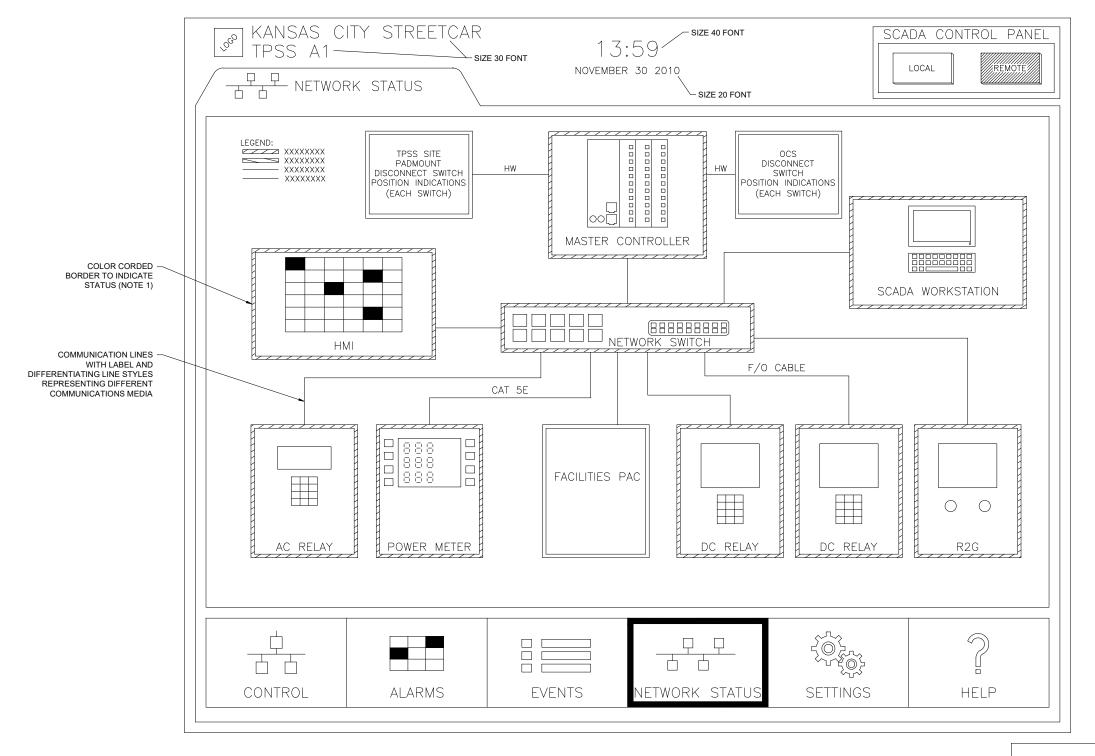

- 1. NOT USED.
- 2. HEADER INFORMATION SHALL BE VIEWABLE AT ALL TIMES.
- 3. EXTEND GUI TO FULL DIMENSIONS OF HMI SCREEN

DRAWING FOR CONTRACTOR COORDINATION PURPOSES. TPSS SHALL BE OWNER SUPPLIED WHEN AVAILABLE.

REV	DATE	DESCRIPTION		DESIGNED BY	JDW	
]		
				CHECKED BY	PGL	
				DRAWN BY	JDW	
				-		
				CHECKED BY	PGL	⊁
				APPROVED BY	NKS	
PLOT DATE:	12/21/202	2	5:17:37 PM	DATE	12/23/2022	

RideKC STREETCAR

This set of plans is not for These plans are ntended to build interest in bidding





NOT FOR CONSTRUCTION

Chelmsford, MA 01824 Phone: 978-905-4000 Certificate of Authority: 001270


TRACTION POWER TYPICAL TPSS HMI NETWORK STATUS SCREEN LAYOUT

DATE: 12-23-2022 KANSAS CITY STREETCAR - RIVERFRONT EXTENSION SCALE FOR 22 NOT TO SCALE FILENAME: J690-J693.DWG_ CONTRACT_NO.: CONTRACT NO. ###
VOLUME:

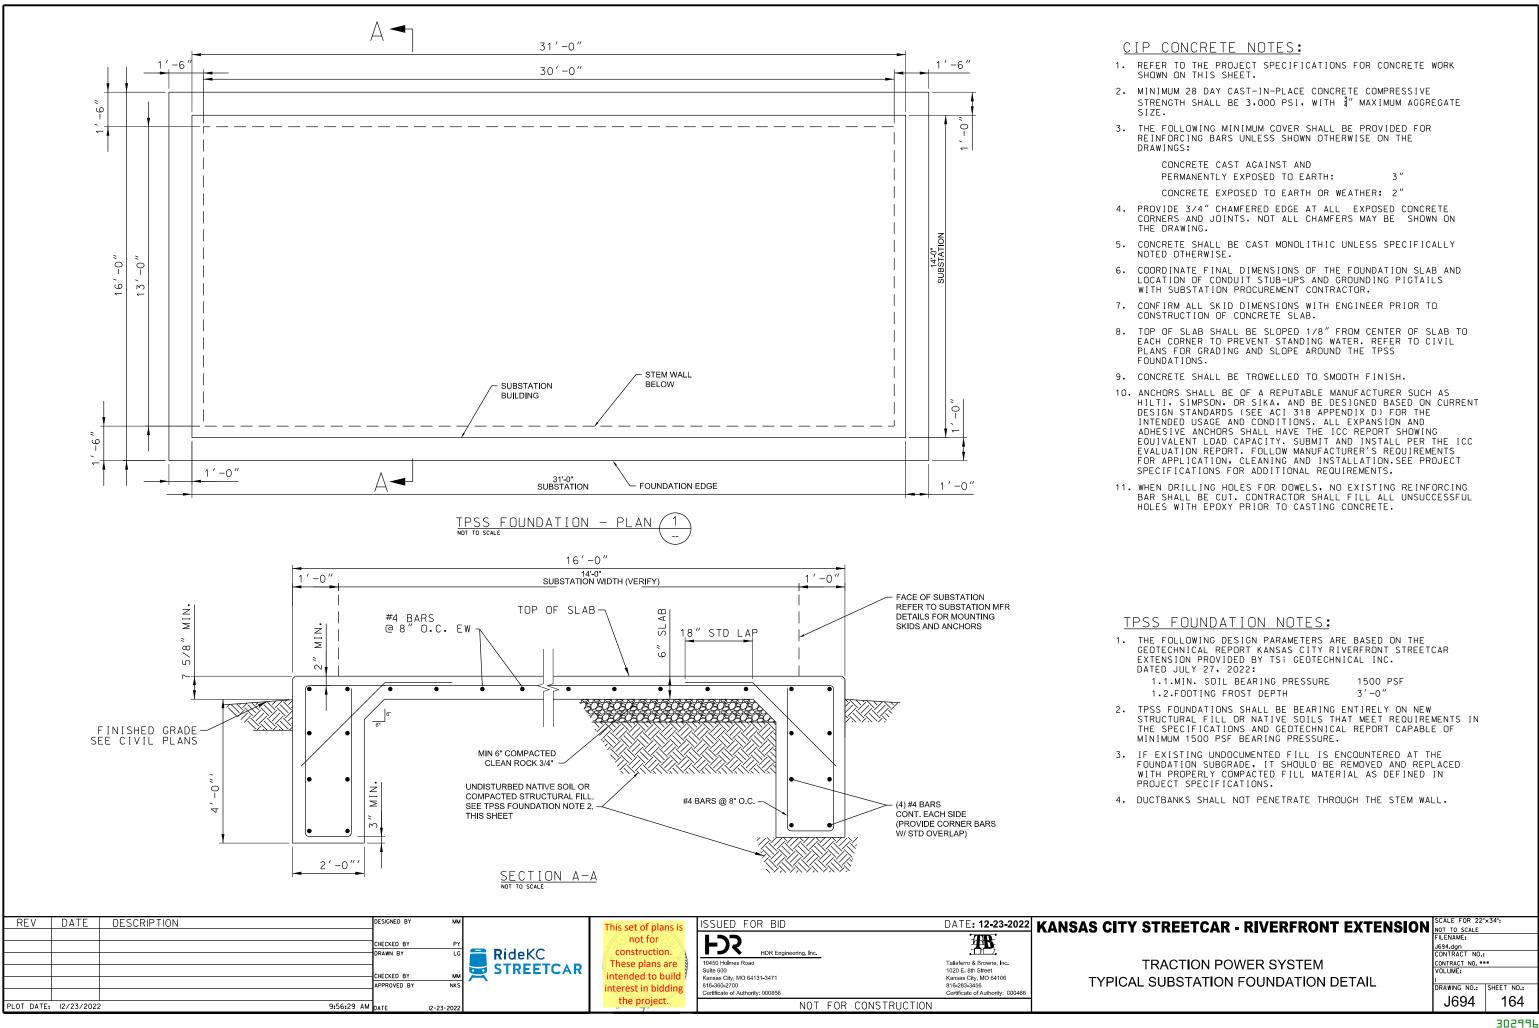

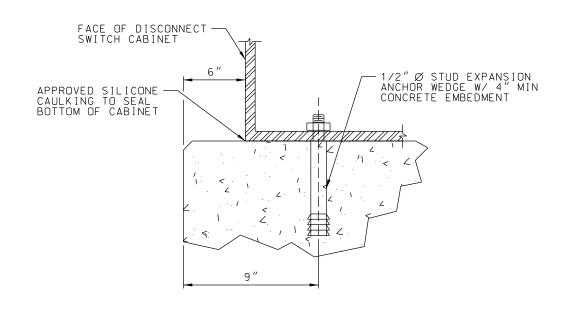

TYPICAL ANCHOR BOLT DETAIL NOT TO SCALE

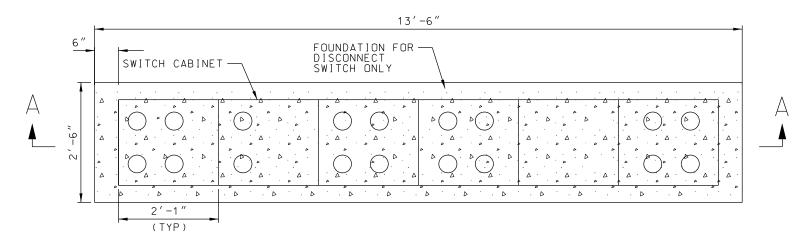

FOUNDATION PLAN (DISCONNECT SWITCH) 2

4" MIN ALL AROUND 3/4 CHAMFER ALL -EXPOSED EDGES #4 @ 8" ± O.C. EW CLR - FINSHED GRADE SECTION A-A CONDUIT (TYP) MIN 6" COMPACTED -CLEAN ROCK UNDISTURBED NATIVE SOIL OR COMPACTED STRUCTURAL FILL SEE TPSS FOUNDATION NOTE 4, THIS SHEET

NOTES:

- 1. VERIFY CONDUIT STUBUP LOCATION AND PAD SIZE REQUIREMENTS WITH THE DISCONNECT SWITCH MANUFACTURER.
- 2. THE FOUNDATION PLAN IS SHOWN FOR A TYPICAL SIX DISCONNECT SWITCH ARRANGEMENT. PROVIDE FOUNDATION FOR OTHER SWITCH ARRANGEMENTS
- 3. SEE ELECTRICAL SITE PLANS FOR CONDUITS.
- THE FOLLOWING DESIGN PARAMETERS ARE BASED ON THE GEOTECHNICAL REPORT KANSAS CITY STREETCAR EXTENSION PHASE II PROVIDED BY TS; GEOTECHNICAL INC. DATED JULY 27, 2022:
 - 1.1. MIN. SOIL BEARING PRESSURE 1500 PSF 1.2. FOOTING FROST DEPTH

REV	DATE	DESCRIPTION			DESIGNED BY	ММ			
					CHECKED BY	PY	_		
					DRAWN BY	LG		RideKC	
							$\overline{}$	STREETCAR	
					CHECKED BY	ММ	$\boldsymbol{\asymp}$	SINCELICAN	
					APPROVED BY	NKS			
									l
PLOT DATE:	12/23/2022	2		9:56:31 AM	DATE	12-23-2022			

This set of plans i not for construction. These plans are intended to build nterest in bidding the project.

FD3

SSUED FOR BID 10450 Holmes Road Suite 600 Kansas City, MO 64131-3471 816-360-2700 Certificate of Authority: 000856 Taliaferro & Browne, Inc. 1020 E. 8th Street Kansas City, MO 64106 816-283-3456 Certificate of Authority: 00046

NOT FOR CONSTRUCTION

DATE: 12-23-2022 KANSAS CITY STREETCAR - RIVERFRONT EXTENSION SCALE FOR 22' NOT TO SCALE FILENAME: TRACTION POWER SYSTEM TYPICAL PAD MOUNTED

DISCONNECT SWITCH FOUNDATION DETAILS

J695.dgn CONTRACT NO.: CONTRACT NO. ***
VOLUME: DRAWING NO.: SHEET NO.: J695 165