KANSAS CITY AREA TRANSPORTATION AUTHORITY WITH



CITY OF KANSAS CITY, MISSOURI KANSAS CITY STREETCAR AUTHORITY PORT AUTHORITY OF KANSAS CITY, MO 💂 RIDERCAR



portkc





KANSAS CITY STREETCAR UTILITY CONTACTS

RIVERFRONT EXTENSION

FTA FAIN # MO-2022-002-00

KCATA PROJECT No.: 2021-SC-3P01

KCMO PROJECT No.: 89022015

ISSUED FOR BID

DECEMBER 2022

(T49N, R33W)

https://www.kcata.org/about_kcata/entries/current_opportunities

101 Holmes Road Kansas City, MO 64106 Jason Cantrell: 913-488-8489 Jason.Cantrell@sprint.com

Jerry Woodall: 913-645-5032

711 F 19th St

Tmobile & AXON

Kansas City, MO 64108

Jerry. Woodall@Lumen.com

Unite Private Networks 7200 NW 86th Street Suite M, Kansas City, MD 64153 Harold Kalwei: 816-500-3737 Harold, Kalwei @upnfiber, com

Verizon Business 10740 Nall Avenue Suite 400 Overland Park, KS 66211 Bryan Burger: 913-344-2007 GregLink@google.com Bryan.Burger@verizon.com

> Windstream Communications 10405 Baur Blvd Suite C Olivette, MO 63132 Jeremy Smiddie: 618-383-4032 Jeremy. Smiddie@windstream.com

> > Zayo (AboveNet, AFS) 1937 S Drumm Avenue Independence, MO 64055 Dwight Davis: 816-254-8027 Dwight, Davis@zayo, com


Vicinity Energy (Trigen) 115 Grand Boulevard Kansas City, MO 64106 Craig McNeil: 816-889-4924 Craig. Mcniel@veolia.com

Kansas City, Missouri Water Services Department: Water 4800 E 63rd Street, Kansas City, MO 64130 Reza Zonnooz: 816-513-0309 Reza.Zonnooz@kcmo.org

Kansas City, Missouri Water Services Department: Sanitary 4800 E 63rd Street, Kansas City, MO 64130 Karine Papikan: 816-513-0300

Karine, Papikian@kcmo.org

This work will be called Package 6 (Pkg 6) and will be posted on KCATA's website for a General Contractor bid.

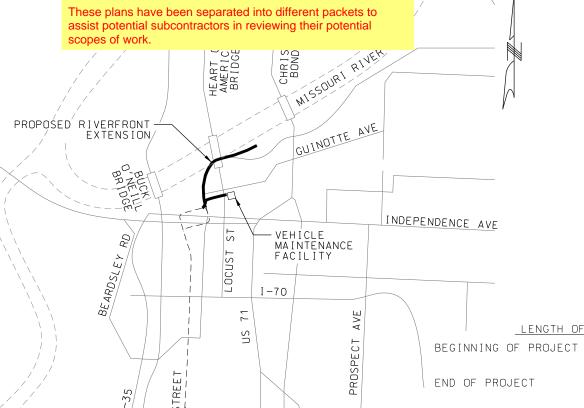

MAINLINE

APPROVED BY

KCATA PROJECT MANAGER

KCATA CHIEF ENGINEER

KCMO DIRECTOR OF TRANSPORTATION

KCMO CITY ENGINEER

KCMO DIRECTOR OF PUBLIC WORKS

KANSAS CITY STREETCAR AUTHORITY

PORT AUTHORITY OF KANSAS CITY, MISSOURI

ENTRY NO.

C.D. NO. LENGTH OF PROJECT

> STA 113+00.00 NB MAINLINE STA 199+89.24 SB MAINLINE STA 150+82.51 NB MAINLINE

STA 236+48.29 SB MAINLINE PROJECT TRACK LENGTH

7,442 TF (1.4 MILES)

3,783 TF NB 3,659 TF SB

TOTAL TRACK LENGTH

Suite 600 816-360-2700 Certificate of Authority: 000856 This set of plans is not for construction. These plans are intended to build nterest in bidding 102 the project.

SCALE FOR 22"x34" NOT TO SCALE FILENAME: GOOI.dgn CONTRACT NO.: CONTRACT NO. ***
VOLUME:

DRAWING NO.: SHEET NO.: G001

2121 East 63rd Street Kansas City, MO 64130 Mark Manion: 816-214-2322 MM256+@a++.com

Consolidated Communications 14859 W 95th Street Lenexa, KS 66215 Clarence Griffin: 913-322-9619 Clarence.Griffin@consolidated.com

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Spectrum/Charter 8221 W. 119th Street Overland Park, Kansas 66213 Josh Cubley: 913-601-2504 Josh.Cubley@charter.com

Spire Energy 7500 E 35th Terrace Kansas City, MO 64129 Richi Garcia: 816-507-0713 Richi, Garcia@spireenergy, com Kansas City, MO 64131-3471

wg TITLE	DESCRIPTION	# dwg TITLE	DESCRIPTION
	GENERAL SHEETS	60 K304A SOUTHBOUND 115RE TRACK PROFILE	SB STA 211+00 TO STA 215+00
GOO1 TITLE SHEET AND LOCATION MAP		61 K305 NORTHBOUND 115RE TRACK PLAN AND PROFILE	NB STA 125+00 TO STA 129+00
GO10 INDEX OF DRAWINGS	SHEET 1	62 K305A SOUTHBOUND 115RE TRACK PROFILE	SB STA 215+00 TO STA 219+00
GO11 INDEX OF DRAWINGS	SHEET 2	63 K306 NORTHBOUND 115RE TRACK PLAN AND PROFILE	NB STA 129+00 TO STA 133+00
G012 INDEX OF DRAWINGS	SHEET 3	64 K306A SOUTHBOUND 115RE TRACK PROFILE	SB STA 219+00 TO STA 223+00
G013 INDEX OF DRAWINGS	SHEET 4		TRACK DETAILS
GO30 STANDARD ABBREVIATIONS	SHEET 1 OF 2	65 K901 TRACK SLAB DETAILS	DETAIL SHEET 1 OF 5
GO31 STANDARD ABBREVIATIONS	SHEET 2 OF 2	66 K902 TRACK SLAB DETAILS	DETAIL SHEET 2 OF 5
G032 OCS GENERAL SYMBOLS AND ABBREVIATIONS		67 K903 TRACK SLAB DETAILS	DETAIL SHEET 3 OF 5
G035 STANDARD SYMBOLS		68 K904 TRACK SLAB DETAILS	DETAIL SHEET 4 DF 5
GO36 TRACTION POWER SYMBOLS		69 K905 TRACK SLAB DETAILS	DETAIL SHEET 5 OF 5
G037 TRACTION POWER ABBREVIATIONS		70 K906 115 RE AND 112 TRAM RAIL SECTIONS	
GO38 SYSTEMWIDE ELECTRICAL ABBREVIATIONS AND SYMBOLS		71 K907 TRANSITION RAIL	
GO40 GENERAL NOTES		72 K908 25M/25M EQUILATERAL CONTINOUSLY CURVED FROG TURNOUT	
GO41 OCS GENERAL NOTES		73 K909 25M CONTINUOUSLY CURVED FROG TURNOUT	
G042 OCS STRUCTURAL STEEL AND CONCRET NOTES		74 K910 25M CONTINUOUSLY CURVED FROG TURNOUT	
G043 TRACTION POWER GENERAL NOTES		75 K911 25M STRAIGHT FROG TURNOUT	
THE TOTAL POINT OF THE POINT WORLD	SURVEY CONTROL	76 K912 TURNOUT ENCAPSULATION AND SECTION DETAILS	
SV001 SURVEY CONTROL	SHEET 1 OF 2	77 K913 MANHOLE REBAR DETAIL	DETAIL SHEET 1 OF 2
SV002 SURVEY CONTROL	SHEET 2 OF 2	78 K914 MANHOLE REBAR DETAIL	DETAIL SHEET 2 OF 2
SANGE SOURCE CONTINUE	DEMOLITION PLANS	79 K915 TRACK DRAIN DETAILS	DETAIL SHEET 2 OF 2
C501 DEMOLITION PLAN		80 K916 HORIZONTAL PRECURVED RAIL LOCATION MAP	
C501 DEMOLITION PLAN	NB STA BEGIN TO STA 113+00		
C502 DEMOLITION PLAN	NB STA 113+00 TO STA 117+92	81 K917 HORIZONTAL PRECURVED RAIL DETAILS	
C503 DEMOLITION PLAN	NB STA 117+92 TO STA 121+00	82 K918 RESTRAINING RAIL	
C504 DEMOLITION PLAN	NB STA 121+00 TO STA 125+00	83 K919 INSULATED JOINT 115 RE RAIL	
C505 DEMOLITION PLAN	NB STA 125+00 TO STA 129+00	84 K920 TRACK SLAB JOINTS	
C506 DEMOLITION PLAN	NB STA 129+00 TO STA 133+00	85 K921 END OF LINE CURB STOP	
C507 DEMOLITION PLAN	NB STA 133+00 TO STA 135+50	86 K922 TRACK SLAB INFILL GRADING DETAIL	
C508 DEMOLITION PLAN	NB STA 135+50 TO STA 139+50	87 K923 112 TRAM RAIL EXPANSION JOINTS	
C509 DEMOLITION PLAN	NB STA 139+50 TO STA 143+50	88 K923A 115 RE RAIL EXPANSION JOINTS	
C510 DEMOLITION PLAN	NB STA 143+50 TO STA 147+50	89 K924 NO. 4 STRAIGHT FROG CROSSOVER	
C511 DEMOLITION PLAN	NB STA 147+50 TO END		CIVIL DETAILS
C512 DEMOLITION PLAN	2ND STREET TO VMF	90 COO1 TYPICAL SECTIONS 1	
	TRACK PLAN AND PROFILES	91 COO2 TYPICAL SECTIONS 2	
KOO1 TRACK KEY MAP		92 COO3 TYPICAL SECTIONS 3	
K101 NORTHBOUND TRACK PLAN AND PROFILE	NB STA BEGIN TO STA 113+50	93 COO4 TYPICAL DRIVEWAY DETAILS	
K101A EXISTING TRACK TIE-IN PROFILE STA -1+00 TO STA 2+50	SB TRACK PROFILE STA 199+00 TO STA 203+00	94 COO5 TYPICAL CURB DETAILS	
K102 NORTHBOUND TRACK PLAN AND PROFILE	NB STA 113+50 TO STA 117+00	95 COO6 MISCELLANEOUS CIVIL DETAILS	
K102A VMF LEAD PROFILE STA -0+50 TO STA 3+00	SB TRACK PROFILE STA 203+00 TO STA 207+00		CIVIL PLANS
K103 NORTHBOUND TRACK PLAN AND PROFILE	NB STA 117+00 TO STA 121+00	96 C101 CIVIL PLAN	NB STA BEGIN TO STA 113+00
K103A SOUTHBOUND TRACK PROFILE	SB STA 207+00 TO STA 211+00	97 C102 CIVIL PLAN	NB STA 113+00 T0 STA 117+00
K104 NORTHBOUND TRACK PLAN AND PROFILE	NB STA 121+00 TO STA 125+00	98 C103 CIVIL PLAN	NB STA 117+00 TO STA 121+00
K104A SOUTHBOUND TRACK PROFILE	SB STA 211+00 TO STA 215+00	99 C104 CIVIL PLAN	NB STA 121+00 TO STA 125+00
K105 NORTHBOUND TRACK PLAN AND PROFILE	NB STA 125+00 TO STA 129+00	100 C105 CIVIL PLAN	NB STA 125+00 TO STA 129+00
K105A SOUTHBOUND TRACK PROFILE	SB STA 215+00 TO STA 129+00	100 C105 CIVIL PLAN	NB STA 129+00 TO STA 133+00
K106 NORTHBOUND TRACK PLAN AND PROFILE	NB STA 129+00 TO STA 133+00	102 C107 CIVIL PLAN	NB STA 129+00 TO STA 135+00 NB STA 133+00 TO STA 135+50
K106A SOUTHBOUND TRACK PROFILE	SB STA 219+00 TO STA 223+00	103 C108 CIVIL PLAN	NB STA 135+50 TO STA 139+50
K107 NORTHBOUND TRACK PLAN AND PROFILE	NB STA 133+00 TO STA 135+50	104 C109 CIVIL PLAN	NB STA 139+50 TO STA 143+50
K107A SOUTHBOUND TRACK PROFILE	SB STA 223+00 TO STA 225+50	105 C110 CIVIL PLAN	NB STA 143+50 TO STA 147+50
K108 NORTHBOUND TRACK PLAN AND PROFILE	NB STA 135+50 TO STA 139+50	106 C111 CIVIL PLAN	NB STA 147+50 TO END
K108A SOUTHBOUND TRACK PROFILE	SB STA 225+50 TO STA 229+50	107 C112 CIVIL PLAN	2ND STREET TO VMF
K109 NORTHBOUND TRACK PLAN AND PROFILE	NB STA 139+50 TO STA 143+50		STREETCAR STOP DETAILS
K109A SOUTHBOUND TRACK PROFILE	SB STA 229+50 TO STA 233+50	108 C201 STREETCAR STOP	NB "RIVER MARKET NORTH"
K110 NORTHBOUND TRACK PLAN AND PROFILE	NB STA 143+50 TO STA 147+50	109 C202 STREETCAR STOP	NB/SB "RIVERFRONT"
K110A SOUTHBOUND TRACK PROFILE	SB STA 233+50 TO STA 237+50		ADA PLANS
K111 NORTHBOUND TRACK PLAN AND PROFILE	NB STA 147+50 TO STA 150+83	110 C301 ADA CURB RAMPS LAYOUT PLAN	RAMP NOTES AND DETAILS
K112 NORTHBOUND TRACK PLAN AND PROFILE	2ND STREET TO VMF	111 C302 ADA CURB RAMP STANDARD DETAILS	SHEET 1 OF 2
K113 NORTHBOUND TRACK PLAN AND PROFILE	2ND STREET TO VMF	112 C303 ADA RAMP STANDARD DETAILS	SHEET 2 OF 2
	TRACK ALIGNMENT TABLES	113 C304 3RD STREET AND GRAND BOULEVARD	GRADING PLAN
K200 TRACK ALIGNMENT TABULATION		114 C305 2ND STREET AND GRAND BOULEVARD	GRADING PLAN
K201 TRACK ALIGNMENT TABULATION		115 C306 GRADING LAYOUT PLANS	2ND STREET TO VMF
	TRACK PLANS 115RE	116 C307 GRADING LAYOUT PLANS	
K303 NORTHBOUND 115RE TRACK PLAN AND PROFILE	NB STA 117+00 TO STA 121+00	117 C308 GRADING LAYOUT PLANS	
K303A SOUTHBOUND 115RE TRACK PROFILE	SB STA 207+00 TO STA 211+00	118 C309 GRADING LAYOUT PLANS	
	NB STA 121+00 TO STA 125+00	119 C310 GRADING LAYOUT PLANS	
B K304 NORTHBOUND 115RE TRACK PLAN AND PROFILE			

REV	DATE	DESCRIPTION		DESIGNED BY	ммо
				CHECKED BY	JWR
				DRAWN BY	MMQ
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				CHECKED BY	JWR
				APPROVED BY	NKS
PLOT DATE:	\$DATE\$		\$TIME\$	DATE	12-23-2022



This set of plans is not for These plans are intended to build interest in bidding 22 the project.

ISSUED FOR BID 10450 Holmes Road Suite 600 Kansas City, MO 64131-3471 816-360-2700 Certificate of Authority: 000856 NOT FOR CONSTRUCTION

DATE: 12-23-2022 KANSAS CITY STREETCAR - RIVERFRONT EXTENSION NOT TO SCALE FILENAME: GOIO.dgn CONTRACT NO.: CONTRA SHEET 1

DRAWING NO.: SHEET NO.: G010

dwg TITLE	DESCRIPTION	# dwg TITLE	DESCRIPTION
C311 GRADING LAYOUT PLANS		181 P310 "TYPE B" SHELTER	PLANS AND ELEVATIONS
C312 GRADING LAYOUT PLANS		182 P311 "TYPE B" SHELTER	SHELTER ROOF PLAN AND RCP
C313 GRADING LAYOUT PLANS		183 P312 "TYPE B" SHELTER	SHELTER ENLARGED PLANS
C314 GRADING LAYOUT PLANS		184 P313 "TYPE B" SHELTER	ENLARGED ELEVATION AND SECTION
C315 POINT TABLES		185 P361 SHELTER DETAILS	Energy Country and October
C316 POINT TABLES		186 P362 SHELTER DETAILS	
10000	TPSS PLANS	187 P363 "TYPE B" SHELTER DETAILS	ADD ALTERNATE
C401 TRACTION POWER SUBSTATION (TPSS)	RIVERFRONT GRADING PLAN	188 P371 MARKER SECTION AND DETAILS	ADD ACTEMIATE
C402 TRACTION POWER SUBSTATION (TPSS)	RIVERFRONT DUCTBANK PLAN	189 P372 MARKER SECTION AND DETAILS	
C403 TRACTION POWER SUBSTATION (TPSS)	RIVERFRONT DUCTBANK PROFILE 1	190 P380 ELECTRICAL LIGHTING PLANS AND FIXTURE SCHEDULE	
C404 TRACTION POWER AND SCADA SYSTEM	TYPICAL DUCTBANK SECTIONS	191 P401 PLATFORM ITS AND ELECTRICAL GENERAL NOTES	
C404 TRACTION POWER AND SCADA SISTEM C405 TRACTION POWER SUBSTATION (TPSS)	DUCTBANK SPECIAL DETAILS	192 P402 PLATFORM ROADSIDE ITS 343 CABINET DIAGRAM	
C406 TRACTION POWER SUBSTATION (TPSS)			
	TYPICAL LOW VOLTAGE 5'X7' MANHOLE DETAILS	193 P403 CCTV ATTACHMENT ON OCS AND LIGHT POLE DETAILS 194 P404 STREETCAR STOP "RIVER MARKET NORTH"	SUSCITIONAL AND LITE DUAY
· ·	COMMUNICATIONS AND STRAY CURRENT PULLBOX TYPICAL DETAILS	194 P404 STREETCAR STOP "RIVER MARKET NURTH"	ELECTRICAL AND ITS PLAN
C408 TRACTION POWER SUBSTATION (TPSS)	TYPICAL NEGATIVE RETURN DETAIL TRACK BLOCKOUT DETAIL AND TYPICAL CONDUIT STUB-		TYPICAL STOP ELECTRICAL SCHEDULES AND DETAILS
C409 TRACTION POWER SUBSTATION (TPSS)	TYPICAL NEGATIVE RETURN DETAIL TRACK BLOCKOUT DETAIL AND TYPICAL CONDUIT STUB-	UP DETAIL 196 19406 118 TYPICAL DRAWING	TYPICAL STOP ELECTRICAL SCHEDULES AND DETAILS
	TPSS DETAILS		PLATFORM STRUCTURAL
J101 TRACTION POWER SYSTEM	MASTER SINGLE LINE DIAGRAM RIVERFRONT EXTENSION	197 PSO01 STRUCTURAL GENERAL NOTES	
J610 TRACTION POWER	TYPICAL MAINLINE TPSS SINGLE LINE SINGLE LINE DIAGRAM	198 PS002 INSPECTION - IBC 2018	
J620 TRACTION POWER	TYPICAL PREFABRICATED TPSS PLAN EQUIPMENT LAYOUT PLAN	199 PS101 "TYPE A" SHELTER - FOUNDATION AND FRAMING PLANS	
J621 TRACTION POWER	TYPICAL PREFABRICATED TPSS - EXTERIOR ELEVATIONS ELEVATION VIEW	200 PS102 "TYPE B" SHELTER - FOUNDATION AND FRAMING PLANS	
J622 TRACTION POWER	TYPICAL PREFABRICATED TPSS INTERIOR ELEVATIONS INTERIOR ELEVATIONS	201 PS201 "TYPE A" SHELTER - SECTIONS AND ELEVATIONS	
J623 TRACTION POWER	TYPICAL SURGER ARRESTER INTERIOR ELEVATIONS	202 PS202 "TYPE B" SHELTER - SECTIONS AND ELEVATIONS	
J630 TRACTION POWER	TPSS D1 SITE RACEWAY LAYOUT	203 PS301 TYPICAL CONCRETE DETAILS	
J632 TRACTION POWER	TPSS D1 GROUND GRID LAYOUT	204 PS302 "TYPE A" SHELTER CONCRETE DETAILS	
J640 TRACTION POWER	TYPICAL DISCONNECT SWITCH ARRANGEMENT	205 PS303 "TYPE B" SHELTER CONCRETE DETAILS	
J642 TRACTION POWER	120/208V AC PANEL ADP PANEL SCHEDULE	205 PS501 TYPICAL STEEL SECTIONS AND DETAILS	
		206 FSSUT TIFICAL STEEL SECTIONS AND DETAILS	DI ATEODY SI SWATION DI ANG
J643 TRACTION POWER	125V DC PANEL DDP PANEL SCHEDULE		PLATFORM ELEVATION PLANS
J644 TRACTION POWER	TYPICAL TPSS LIGHTING SCHEMATIC	207 P501 "RIVER MARKET NORTH" PLATFORM	SIGNAGE LOCATION ELEVATION
J645 TRACTION POWER	TYPICAL TPSS RECEPTACLES AND SMOKE DETECTOR SCHEMATIC	208 P502 "RIVERFRONT" PLATFORM	SIGNAGE LOCATION ELEVATION
J646 TRACTION POWER	TYPICAL TPSS HVAC AND VENTILATION SCHEMATIC	209 P503 SIGNAGE TYPES OVERVIEW	
J648 TRACTION POWER	LOGIC DIAGRAMS SYMBOLS AND LEGEND	210 P504 SIGNAGE TYPES OVERVIEW	
J649 TRACTION POWER	SUBSTATION LOCKOUT AND ALARM LOGIC DIAGRAM	211 P505 SIGNAGE TYPES OVERVIEW	
J650 TRACTION POWER	AC SWITCHGEAR INCOMING CUBICLE LOGIC DIAGRAM	212 P506 SIGNAGE TYPES OVERVIEW	
J652 TRACTION POWER	TYPICAL DC FEEDER CUBICLE LOGIC DIAGRAM SHEET 1 OF 2	213 P507 "RIVER MARKET NORTH" PLATFORM	WAYFINDING PLAN
J653 TRACTION POWER	TYPICAL DC FEEDER CUBICLE LOGIC DIAGRAM SHEET 2 OF 2		TRAFFIC SIGNAL LAYOUT PLANS
J654 TRACTION POWER	NEGATIVE AND POSITIVE DISCONNECT SWITCH LOGIC DIAGRAM	1914 T100 TRAFFIC SIGNAL GENGRAL NOTES	
J660 TRACTION POWER	STATION CONTROL CABINET TYPICAL LAYOUT	215 TIO1 TRAFFIC SIGNAL LAYOUT PLAN	STREET AND GRAND BOULEVARD
J661 TRACTION POWER	RAIL TO GROUND (R2G) CABINET TYPICAL LAYOUT	216 T101A TRAFFIC SIGNAL LAYOUT PLAN	3RD STREET AND GRAND BOULEVARD
J665 TRACTION POWER	TPSS COMMUNICATIONS BLOCK DIAGRAM	217 T101B TRAFFIC SIGNAL WIRING DIAGRAM AND PHASING	3RD STREET AND GRAND BOULEVARD
J673 TRACTION POWER	TYPICAL GROUNDING DETAILS	218 T101C TRAFFIC SIGNAL SUMMARY OF QUANTITIES	3RD STREET AND GRAND BOULEVARD
J680 TRACTION POWER	D1 CONDUCTOR SCHEDULE	219 T102 TRAFFIC SIGNAL LAYOUT PLAN	2ND STREET AND GRAND BOULEVARD
J690 TRACTION POWER			
	TYPICAL TPSS HMI ALARM SCREEN LAYOUT	220 T102A TRAFFIC SIGNAL LAYOUT PLAN	2ND STREET AND GRAND BOULEVARD
J691 TRACTION POWER	TYPICAL TPSS HMI CONTROL SCREEN LAYOUT	221 T102B TRAFFIC SIGNAL WIRING DIAGRAM AND PHASING	2ND STREET AND GRAND BOULEVARD
J692 TRACTION POWER	TYPICAL TPSS HMI EVENT LOG SCREEN LAYOUT	222 T102C TRAFFIC SIGNAL SUMMARY OF QUANTITIES	2ND STREET AND GRAND BOULEVARD
J693 TRACTION POWER	TYPICAL TPSS HMI NETWORK STATUS SCREEN LAYOUT	223 T103 TRAFFIC SIGNAL LAYOUT PLAN	BERKLEY PARKWAY / RIVERFRONT DRIVE
J694 TRACTION POWER	TYPICAL SUBSTATION FOUNDATION DETAIL	224 T103B TRAFFIC SIGNAL WIRING DIAGRAM AND PHASING	BERKLEY PARKWAY / RIVERFRONT DRIVE
J695 TRACTION POWER	TYPICAL PAD MOUNTED DISCONNECT SWITCH FOUNDATION DETAILS	225 T103C TRAFFIC SIGNAL SUMMARY OF QUANTITIES	BERKLEY PARKWAY / RIVERFRONT DRIVE
	DRAINAGE PLANS		TRAFFIC SIGNAL DETAILS
D101 DRAINAGE PLAN	NB STA BEGIN TO STA 113+00	226 T201 TRAFFIC SIGNAL DETAILS	CROSS SPAN JOINT USE TRAFFIC/OCS POLE
D102 DRAINAGE PLAN	NB STA 113+00 TO STA 117+00	227 T202 TRAFFIC SIGNAL DETAILS	AUXILIARY CABINET MOUNTING DETAIL
D103 DRAINAGE PLAN	NB STA 117+00 TO STA 121+00	228 T203 TRAFFIC SIGNAL DETAILS	TRAFFIC SIGNAL SYMBOLS
D106 DRAINAGE PLAN	NB STA 129+00 TO STA 133+00	229 T204 TRAFFIC SIGNAL DETAILS	SIGNAL HEAD DETAILS
D109 DRAINAGE PLAN	NB STA 139+50 TO STA 143+50	230 T205 TRAFFIC SIGNAL DETAILS	SIGNAL MAST ARM DETAILS
D110 DRAINAGE PLAN	NB STA 143+50 TO STA 147+50	231 T206 TRAFFIC SIGNAL DETAILS	SIGNAL CONCRETE BASE DETAILS
D111 DRAINAGE PLAN	NB STA 147+50 TO END	231 T206 TRAFFIC SIGNAL DETAILS	SIGNAL PULL BOX DETAILS
	UND DI OCTIFII ALC DN		
D301 MISCELLANEOUS DRAINAGE DETAILS	0.475000	233 T208 TRAFFIC SIGNAL DETAILS	SIGNAL PULL BOX DETAILS
	PLATFORMS	234 T209 TRAFFIC SIGNAL DETAILS	SIGNAL PTZ CAMERA INSTALL DETAILS
P101 "RIVER MARKET NORTH"	PLATFORM PLAN	235 T210 TRAFFIC SIGNAL DETAILS	PEDESTRIAN PUSHBUTTON POLE DETAILS
P102 "RIVERFRONT"	PLATFORM PLAN	236 T211 TRAFFIC SIGNAL DETAILS	PEDESTRIAN PUSHBUTTON POLE DETAILS
P201 "RIVER MARKET NORTH"	PLATFORM ELEVATION		SIGNING AND STRIPING PLANS
P202 "RIVERFRONT"	PLATFORM ELEVATION	237 SOO1 SIGNING AND STRIPING	GENERAL NOTES
P203 PLATFORM SITE DETAILS		238 S100 SIGNING AND STRIPING PLAN	5TH TO 3RD STREET
P204 PLATFORM SEAT WALL DETAILS		239 S101 SIGNING AND STRIPING PLAN	NB STA BEGIN TO STA 113+00
P302 "TYPE A" SHELTER	PLANS AND ELEVATIONS	240 S102 SIGNING AND STRIPING PLAN	NB STA 113+00 TD STA 117+00
1	,	241 S103 SIGNING AND STRIPING PLAN	NB STA 117+00 TD STA 121+00
		1= : 1 = : 5 5 5 5 5 5 5 5 5 5	1

REV	DATE	DESCRIPTION	DESIGNED BY	ммо
			CHECKED BY	JWR
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			CHECKED BY	JWR
			APPROVED BY	NKS
PLOT DATE:	\$DATF\$	\$TIMF\$	hate	12-23-2022

RideKC STREETCAR

This set of plans is not for construction. These plans are intended to build interest in bidding 22 the project.

ISSUED FOR BID 10450 Holmes Road Suite 600 Kansas City, MO 64131-3471 816-360-2700 Certificate of Authority: 000856 NOT FOR CONSTRUCTION

DATE: 12-23-2022 KANSAS CITY STREETCAR - RIVERFRONT EXTENSION

| SCALE FOR 22'x34': NOT TO SCALE FILENAME: GOILdgo CONTRACT NO.: CONTRACT NO.: CONTRACT NO.: CONTRACT NO.: VOLUME: VOLUME: SHEET 2

DRAWING NO.: SHEET NO.:

DESCRIPTION	# dwg TITLE	DESCRIPTION
NB STA 125+00 TO STA 129+00	303 ST309 BID ALTERNATE - 115RE JOINTS FINGER JOINT MODIFICATION DETAILS	
NB STA 129+00 TO STA 133+00	304 ST310 BID ALTERNATE - 115RE JOINTS STRIP SEAL REMOVAL AND REPLACEMENT PLAN - P	IERS 11 & 12
NB STA 133+00 TO STA 135+50	305 ST311 BID ALTERNATE - 115RE JOINTS STRIP SEAL DETAILS	
NB STA 135+50 TO STA 139+50	306 ST312 BID ALTERNATE - 115RE JOINTS TYPICAL SLAB SECTIONS AND DETAILS	
NB STA 139+50 TO STA 143+50	307 ST313 BID ALTERNATE - 115RE JOINTS SLAB REINFORCING - PIER 2	
2ND STREET TO VMF		
<u> </u>		
TING DI ING		
ING PLANS		
ND CTA DECIN TO CTA 117.00		
		CONTROL PLANS
		NB STA 135+50 TO STA 139+50
		NB STA 139+50 TD STA 143+50
		NB STA 143+50 TD STA 147+50
	329 EC104 EROSION CONTROL PLAN	NB STA 147+50 TO END
		HNICAL SHEETS
	331 YOOS TECHNICAL SHEETS VERTICAL ELECTRICAL CLEARANCE REQUIREMENTS	
	332 YOO6 TECHNICAL SHEETS PANTOGRAPH SECURITY	
	333 YOO7 TECHNICAL SHEETS TYPICAL OFFSET AND STAGGER DETAILS	
	334 YOO8 TECHNICAL SHEETS INSTALLATION TENSION CHART	
CAPE PLANS	335 YOO9 TECHNICAL SHEETS ALONG TRACK MOVEMENT CHART	
BERKLEY PARK - 1	336 YO10 TECHNICAL SHEETS VERTICAL AND RADIAL LOADS	
BERKLEY PARK - 2	337 Y011 TYPICAL ARRANGEMENTS TYPICAL DVERLAP ARRANGEMENT	
BERKLEY PARK - 3	338 Y012 TYPICAL ARRANGEMENTS AT GRAND BOULEVARD VIADUCT	
GRAND BOULEVARD	339 Y013 TYPICAL ARRANGEMENTS AT APPROACH STRUCTURES	
	340 Y021 STRUCTURAL DETAILS TYPICAL POLE DETAIL	
TAILS 112TRAM		
	342 YO25 STRUCTURAL DETAILS DOWN GUY ASSEMBLY	
1 OF 3	343 Y031 STRUCTURAL DETAILS TYPICAL FOUNDATION DETAIL	
= -: -		
3 OF 3	345 Y034 STRUCTURAL DETAILS 2 FT DIAMETER FOUNDATION DETAIL	
PIERS 2 AND 5	346 Y035 STRUCTURAL DETAILS ROCK SOCKET AND DOWN GUY FOUNDATION DETAILS	
PIER 8		
		SHEET 1 OF 2
PIERS 11 AND 12		SHEET 2 OF 2
K DRAIN DETAILS		
 		
057411 C 44505		
JETATES TISKE		
		CUEET 1 OF 2
	360 Y056 REGISTRATION ASSEMBLIES PULLOVER ASSEMBLIES	SHEET 1 OF 2
	361 Y057 REGISTRATION ASSEMBLIES PULLOVER ASSEMBLIES	SHEET 2 OF 2
	362 YO58 REGISTRATION ASSEMBLIES PENDULUM SUSPENSION ASSEMBLIES	
	NB STA 121+00 TO STA 125+00 NB STA 125+00 TO STA 129+00 NB STA 129+00 TO STA 139+00 NB STA 133+00 TO STA 135+50 NB STA 135+50 TO STA 139+50 NB STA 135+50 TO STA 139+50 NB STA 135+50 TO STA 143+50 NB STA 143+50 TO STA 143+50 NB STA 143+50 TO STA 143+50 NB STA 143+50 TO STA 147+50 NB STA 147+50 TO END 2ND STREET TO VMF TING PLANS TING PLANS NB STA 113+00 TO STA 117+00 NB STA 113+00 TO STA 125+00 NB STA 129+00 TO STA 129+00 NB STA 129+00 TO STA 139+50 NB STA 133+50 TO STA 133+50 NB STA 133+50 TO STA 133+50 NB STA 133+50 TO STA 133+50 NB STA 133+50 TO STA 147+50 NB STA 143+50 TO STA 147+50 NB STA 143+50 TO STA 147+50 NB STA 143+50 TO STA 147+50 NB STA 147+50 TO END 2ND STREET TO VMF ING DETAILS CAPE PLANS BERKLEY PARK - 1 BERKLEY PARK - 2 BERKLEY PARK - 2 BERKLEY PARK - 2 BERKLEY PARK - 3 GRAND BOULEVARD TAILS 112TRAM	180 \$1.5 \$1.5 \$1.0 \$1.5 \$

REV	DATE DESCRIPTION	DESIGNED BY	мо	This set of plans is	ISSUED FOR BID DATE: 12-23-202	KANSAS CITY STREETCAR - RIVERFRONT EXTENSION	SCALE FOR 22"×34":
		CHECKED BY	WR	not for	F.75	ANORO OF FOREETORY - RIVER ROW EXTENSION	FILENAME:
		DRAWN BY	RideKC STREETCAR	construction. These plans are	HDR Engineering, Inc. 10450 Holmes Road		CONTRACT NO.: CONTRACT NO. ***
		CHECKED BY APPROVED BY	WR STREETCAR	intended to build	Suite 600 Kansas City, MO 64131-3471 816-360-2700	SHEET 3	VOLUME: I DRAWING NO.: SHEET NO.:
PLOT DATE	E: \$DATE\$	ME\$ DATE 12-23-2	22	the project.	Certificate of Authority: 000856 NOT FOR CONSTRUCTION		G012 4

# dwg TITLE DESCRIPT	PTION	# dwg		DESCRIPTION
364 YO61 IN-SPAN ASSEMBLIES JUMPER ASSEMBLIES			COMMUNICATIONS DETAILS	RING DIAGRAM SHEET 4
365 Y062 IN-SPAN ASSEMBLIES SECTION INSULATOR ASSEMBLY			COMMUNICATIONS DETAILS	RING DIAGRAM SHEET 5
366 YO63 IN-SPAN ASSEMBLIES TYPICAL SPLICE DETAILS			COMMUNICATIONS DETAILS	3RD ST SPLICE
367 Y064 IN-SPAN ASSEMBLIES SPAN SPACER AND CROSS CONTACT WIRE CLAMP ASSEMBLIES		430 Z621		3RD ST SPLICE INSET
368 YO65 IN-SPAN ASSEMBLIES CONTACT WIRE PROTECTION BOARD			COMMUNICATIONS DETAILS	2ND ST SPLICE
369 YOG6 SWITCHING AND FEEDER ASSEMBLIES FEEDER TAP DETAILS			COMMUNICATIONS DETAILS	SUB STATION SPLICE
370 Y067 SWITCHING AND FEEDER ASSEMBLIES SURGE ARRESTER DETAILS			COMMUNICATIONS DETAILS	BERKLEY PKWY SPLICE
371 YOS SECTIONALIZING DIAGRAM			COMMUNICATIONS DETAILS	RIVERFRONT SPLICE DIAGRAM
372 Y069 POLE GROUND WIRE INSTALLATION GRAND BOULEVARD VIADUCT PIERS 373 Y070 SWITCHING FEEDER ASSEMBLIES FEEDER TAP DETAILS			COMMUNICATIONS DETAILS	RIVERFRONT STATION SPLICE
			ITS CONDUIT HANGER DETAILS	
374 YO71 TERMINATION ASSEMBLIES FIXED TERMINATION ASSEMBLY			CONDUIT TRANSITION DETAIL	
375 YO72 TERMINATION ASSEMBLIES SPRING TENSIONER TERMINATION ASSEMBLY 376 YO81 MISCELLANEOUS POLE NUMBERING DETAIL			ITS CONDUIT TRANSITION BOX DETAIL ITS CONDUIT EXPANSION/DEFLECTION POINT	
377 Y092 CROSS SECTION HEART OF AMERICA BRIDGE			ITS CONDUIT EXPANSION/DEFLECTION POINT	
378 YO93 PROFILES HEART OF AMERICA BRIDGE SHEET 1	00.2	440 2631		CONTROL PLANS
379 Y094 PROFILES HEART OF AMERICA SHEET 2	0, 2	441 N101	TRAIN CONTROL PLAN	3RD & GRAND
380 Y097 CROSS SECTION OCS FEEDING POINT	ur z		TRAIN CONTROL PLAN	2ND & GRAND
381 Y111 STRUCTURE SCHEDULE POLE AND FOUNDATION SCHEDULE SHEET 1	05.2		TRAIN CONTROL PLAN	FRONT & BERKLEY
382 Y112 STRUCTURE SCHEDULE POLE AND FOUNDATION SCHEDULE SHEET 2			TRAIN CONTROL PLAN	RIVERFRONT
382 Y112 STRUCTURE SCHEDULE POLE AND FOUNDATION SCHEDULE SHEET 2			TRAIN CONTROL PLAN	VMF
	· · · · · · · · · · · · · · · · · · ·	143 N105		I SIGNALING
383 Y198 KEY MAP		446 NEOO	TRAIN CONTROL TRACK AND CABLE PLAN	3RD & GRAND
	BEGIN TO STA 113+00		TRAIN CONTROL TRACK AND CABLE PLAN	2ND & GRAND
	113+00 TO STA 117+00		TRAIN CONTROL TRACK AND CABLE PLAN	FRONT STREET
	117+00 TD STA 121+00		TRAIN CONTROL TRACK AND CABLE PLAN	RIVERFRONT
	121+00 TO STA 125+00		TRAIN CONTROL ROUTE AND ASPECT CHART	3RD & GRAND
	125+00 TD STA 129+00		TRAIN CONTROL ROUTE AND ASPECT CHART	2ND & GRAND
	129+00 TD STA 133+00		TRAIN CONTROL ROUTE AND ASPECT CHART	RIVERFRONT
	133+00 TO STA 135+50		TRAIN CONTROL TURNOUT BONDING	TA FER TOWN
	135+50 TO STA 139+50		TRAIN CONTROL	TYPICAL SIGNAL CASE LAYOUT RELAY CASE
	139+50 TO STA 143+50		TRAIN CONTROL	TYPICAL SIGNAL CASE FOUNDATION AND GROUNDING DETAILS
	143+50 TO STA 147+50		TRAIN CONTROL	TYPICAL TWO LOOP INSTALLATION EMBEDDED TRACK
	147+50 TO END		TRAIN CONTROL	CABLE / CONDUIT SCHEDULE
	Y+00 TO STA 121+00		TRAIN CONTROL	CABLE / CONDUIT SCHEDULE
	+00 TO STA 125+00		TRAIN CONTROL	CABLE / CONDUIT SCHEDULE
	5+00 TD STA 129+00			OF WAY PLANS
	1+00 TO STA 133+00	460 RW001	RIGHT OF WAY KEY MAP	
	EET TO VMF		RIGHT OF WAY PLAN	100 GRAND BLVD
401 Y217 OCS LAYOUT PLAN ENLARGED			RIGHT OF WAY PLAN	101 GRAND BLVD
COMMIUNICATION SCHEO			RIGHT OF WAY PLAN	599 E RIVERFRONT ROAD - SHEET 1
402 Z001 COMMUNICATION SCHEDULE			RIGHT OF WAY PLAN	599 E RIVERFRONT ROAD - SHEET 2
COMMIUNICATION PLA	ANS	465 RW105	RIGHT OF WAY PLAN	599 E RIVERFRONT ROAD - SHEET 3
403 Z101 COMMUNICATIONS PLAN NB STA E	BEGIN TO STA 113+00	466 RW106	RIGHT OF WAY PLAN	599 E RIVERFRONT ROAD - SHEET 4
404 Z102 COMMUNICATIONS PLAN NB STA 1	113+00 TO STA 117+00	,		OUR PLAN
405 Z103 COMMUNICATIONS PLAN NB STA 1	117+00 TO STA 121+00	467 DT101	DETOUR PLAN	
406 Z104 COMMUNICATIONS PLAN NB STA 1	121+00 TO STA 125+00			OVERLAY PLANS
	125+00 TO STA 129+00		ROADWAY MILL AND OVERLAY PLAN AND PROFILE	STA 0+00 TD STA 4+00
408 Z106 COMMUNICATIONS PLAN NB STA 1	129+00 TO STA 133+00	469 R102	ROADWAY MILL AND OVERLAY PLAN AND PROFILE	STA 4+00 TO STA 8+00
409 Z107 COMMUNICATIONS PLAN NB STA 1	133+00 TO STA 135+50	470 R103	ROADWAY MILL AND OVERLAY PLAN AND PROFILE	STA 19+00 TO STA 23+00
	135+50 TO STA 139+50		ROADWAY MILL AND OVERLAY PLAN AND PROFILE	STA 23+00 TO STA 28+00
	139+50 TO STA 143+50		ROADWAY MILL AND OVERLAY PLAN AND PROFILE	2ND STREET TO VMF
412 Z110 COMMUNICATIONS PLAN NB STA 1	143+50 TO STA 147+50	473 R201		ALIGNMENT TABLE GRAND BOULEVARD & BERKLEY PARKWAY
413 Z111 COMMUNICATIONS PLAN NB STA 1	147+50 TO END		MILL AND OVER	RLAY CROSS SECTIONS
	EET TO VMF		ROADWAY MILL AND OVERLAY CROSS SECTIONS	GRAND BOULEVARD
COMMIUNICATION DETA	2006	475 XS02	ROADWAY MILL AND OVERLAY CROSS SECTIONS	GRAND BOULEVARD
415 Z601 SYSTEMWIDE ELECTRICAL TYPICAL	. MANHOLE DETAILS	476 XSO3	ROADWAY MILL AND OVERLAY CROSS SECTIONS	GRAND BOULEVARD
415 Z601 SYSTEMWIDE ELECTRICAL TYPICAL 416 Z602 SYSTEMWIDE ELECTRICAL MANHOLE	MANHOLE DETAILS INSTALLATION AND SWITCH HEATER/TRACK CIRCUIT BLOCKOUT DETAILS	476 XS03 477 XS04	ROADWAY MILL AND OVERLAY CROSS SECTIONS	GRAND BOULEVARD
415 Z601 SYSTEMWIDE ELECTRICAL TYPICAL 416 Z602 SYSTEMWIDE ELECTRICAL MANHOLE 417 Z603 SYSTEMWIDE ELECTRICAL FIBER OF	. MANHOLE DETAILS : INSTALLATION AND SWITCH HEATER/TRACK CIRCUIT BLOCKOUT DETAILS PTIC SPLICE VAULT	476 XS03 477 XS04 478 XS05	ROADWAY MILL AND OVERLAY CROSS SECTIONS ROADWAY MILL AND OVERLAY CROSS SECTIONS	GRAND BOULEVARD GRAND BOULEVARD
415 Z601 SYSTEMWIDE ELECTRICAL TYPICAL TYPICAL 416 Z602 SYSTEMWIDE ELECTRICAL MANHOLE A17 Z603 SYSTEMWIDE ELECTRICAL FIBER OF 418 Z604 SYSTEMWIDE ELECTRICAL HANDHOLE HANDHOL	. MANHOLE DETAILS : INSTALLATION AND SWITCH HEATER/TRACK CIRCUIT BLOCKOUT DETAILS PPTIC SPLICE VAULT E DETAILS	476 XS03 477 XS04 478 XS05 479 XS06	ROADWAY MILL AND OVERLAY CROSS SECTIONS ROADWAY MILL AND OVERLAY CROSS SECTIONS ROADWAY MILL AND OVERLAY CROSS SECTIONS	GRAND BOULEVARD GRAND BOULEVARD GRAND BOULEVARD
415 Z601 SYSTEMWIDE ELECTRICAL TYPICAL 416 Z602 SYSTEMWIDE ELECTRICAL MANHOLE 417 Z603 SYSTEMWIDE ELECTRICAL FIBER OF 418 Z604 SYSTEMWIDE ELECTRICAL HANDHOLE 419 Z606 SYSTEMWIDE ELECTRICAL TYPICAL	MANHOLE DETAILS INSTALLATION AND SWITCH HEATER/TRACK CIRCUIT BLOCKOUT DETAILS DPTIC SPLICE VAULT E DETAILS TRACK CIRCUIT BLOCKOUT DETAIL	476 XS03 477 XS04 478 XS05 479 XS06 480 XS07	ROADWAY MILL AND OVERLAY CROSS SECTIONS	GRAND BOULEVARD GRAND BOULEVARD GRAND BOULEVARD BERKLEY PARKWAY
415 Z601 SYSTEMWIDE ELECTRICAL TYPICAL 416 Z602 SYSTEMWIDE ELECTRICAL MANHOLE 417 Z603 SYSTEMWIDE ELECTRICAL FIBER 0 F	MANHOLE DETAILS INSTALLATION AND SWITCH HEATER/TRACK CIRCUIT BLOCKOUT DETAILS IPTIC SPLICE VAULT E DETAILS TRACK CIRCUIT BLOCKOUT DETAIL URNOUT BLOCKOUT DETAIL	476 XS03 477 XS04 478 XS05 479 XS06 480 XS07 481 XS08	ROADWAY MILL AND OVERLAY CROSS SECTIONS	GRAND BOULEVARD GRAND BOULEVARD GRAND BOULEVARD BERKLEY PARKWAY BERKLEY PARKWAY
415 Z601 SYSTEMWIDE ELECTRICAL TYPICAL TRACK TU TYPICAL TYPICA	MANHOLE DETAILS INSTALLATION AND SWITCH HEATER/TRACK CIRCUIT BLOCKOUT DETAILS PITIC SPLICE VAULT E DETAILS TRACK CIRCUIT BLOCKOUT DETAIL URNOUT BLOCKOUT DETAIL DUCTBANK INSTALLATION MANHOLE AND CONDUIT LABELING AND CONDUIT STUB-UP DETAIL	476 XS03 477 XS04 478 XS05 479 XS06 480 XS07 481 XS08 482 XS09	ROADWAY MILL AND OVERLAY CROSS SECTIONS	GRAND BOULEVARD GRAND BOULEVARD GRAND BOULEVARD BERKLEY PARKWAY BERKLEY PARKWAY BERKLEY PARKWAY
415 Z601 SYSTEMWIDE ELECTRICAL TYPICAL 416 Z602 SYSTEMWIDE ELECTRICAL MANHOLE 417 Z603 SYSTEMWIDE ELECTRICAL FIBER OF 418 Z604 SYSTEMWIDE ELECTRICAL HANDHOLE 419 Z606 SYSTEMWIDE ELECTRICAL TYPICAL 420 Z607 SYSTEMWIDE ELECTRICAL TRACK TI 421 Z608 SYSTEMWIDE ELECTRICAL TYPICAL 422 Z609 SYSTEMWIDE ELECTRICAL COMMUNIC	MANHOLE DETAILS INSTALLATION AND SWITCH HEATER/TRACK CIRCUIT BLOCKOUT DETAILS PITIC SPLICE VAULT E DETAILS TRACK CIRCUIT BLOCKOUT DETAIL URNOUT BLOCKOUT DETAIL DUCTBANK INSTALLATION MANHOLE AND CONDUIT LABELING AND CONDUIT STUB-UP DETAIL CATION CONDUIT TYPICAL SECTIONS	476 XS03 477 XS04 478 XS05 479 XS06 480 XS07 481 XS08 482 XS09 483 XS10	ROADWAY MILL AND OVERLAY CROSS SECTIONS	GRAND BOULEVARD GRAND BOULEVARD GRAND BOULEVARD BERKLEY PARKWAY BERKLEY PARKWAY BERKLEY PARKWAY 2ND STREET
415 Z601 SYSTEMWIDE ELECTRICAL TYPICAL 416 Z602 SYSTEMWIDE ELECTRICAL MANHOLE 417 Z603 SYSTEMWIDE ELECTRICAL FIBER OF 418 Z604 SYSTEMWIDE ELECTRICAL HANDHOLE 419 Z606 SYSTEMWIDE ELECTRICAL TYPICAL 420 Z607 SYSTEMWIDE ELECTRICAL TRACK TU 421 Z608 SYSTEMWIDE ELECTRICAL TYPICAL 422 Z609 SYSTEMWIDE ELECTRICAL COMMUNICATIONS DETAILS 423 Z614 COMMUNICATIONS DETAILS NETWORK 424 A65 COMMUNICATIONS DETAILS NETWORK 425 A66 COMMUNICATIONS DETAILS NETWORK 426 A67 COMMUNICATIONS DETAILS NETWORK 427 A67 COMMUNICATIONS DETAILS NETWORK 428 A67 COMMUNICATIONS DETAILS NETWORK 429 A67 COMMUNICATIONS DETAILS NETWORK 440 A67	MANHOLE DETAILS INSTALLATION AND SWITCH HEATER/TRACK CIRCUIT BLOCKOUT DETAILS DITIC SPLICE VAULT E DETAILS TRACK CIRCUIT BLOCKOUT DETAIL URROUT BLOCKOUT DETAIL DUCTBANK INSTALLATION MANHOLE AND CONDUIT LABELING AND CONDUIT STUB-UP DETAIL CATION CONDUIT TYPICAL SECTIONS DIAGRAM	476 XS03 477 XS04 478 XS05 479 XS06 480 XS07 481 XS08 482 XS09 483 XS10 484 XS11	ROADWAY MILL AND OVERLAY CROSS SECTIONS	GRAND BOULEVARD GRAND BOULEVARD GRAND BOULEVARD BERKLEY PARKWAY BERKLEY PARKWAY BERKLEY PARKWAY ZND STREET ZND STREET
415 Z601 SYSTEMWIDE ELECTRICAL	MANHOLE DETAILS INSTALLATION AND SWITCH HEATER/TRACK CIRCUIT BLOCKOUT DETAILS PITIC SPLICE VAULT E DETAILS TRACK CIRCUIT BLOCKOUT DETAIL URNOUT BLOCKOUT DETAIL DUCTBANK INSTALLATION MANHOLE AND CONDUIT LABELING AND CONDUIT STUB-UP DETAIL CATION CONDUIT TYPICAL SECTIONS DIAGRAM AGRAM SHEET 1	476 XS03 477 XS04 478 XS05 479 XS06 480 XS07 481 XS08 482 XS09 483 XS10 484 XS11 485 XS12	ROADWAY MILL AND OVERLAY CROSS SECTIONS	GRAND BOULEVARD GRAND BOULEVARD GRAND BOULEVARD BERKLEY PARKWAY BERKLEY PARKWAY BERKLEY PARKWAY 2ND STREET 2ND STREET 2ND STREET
415 Z601 SYSTEMWIDE ELECTRICAL	MANHOLE DETAILS INSTALLATION AND SWITCH HEATER/TRACK CIRCUIT BLOCKOUT DETAILS DITIC SPLICE VAULT E DETAILS TRACK CIRCUIT BLOCKOUT DETAIL URROUT BLOCKOUT DETAIL DUCTBANK INSTALLATION MANHOLE AND CONDUIT LABELING AND CONDUIT STUB-UP DETAIL CATION CONDUIT TYPICAL SECTIONS DIAGRAM	476 XS03 477 XS04 478 XS05 479 XS06 480 XS07 481 XS08 482 XS09 483 XS10 484 XS11 485 XS12	ROADWAY MILL AND OVERLAY CROSS SECTIONS	GRAND BOULEVARD GRAND BOULEVARD GRAND BOULEVARD BERKLEY PARKWAY BERKLEY PARKWAY BERKLEY PARKWAY BERKLEY PARKWAY ZND STREET ZND STREET

REV	DATE	DESCRIPTION	DESIGNED BY	ммо
			1	
			CHECKED BY	JWR
			DRAWN BY	ммо
			CHECKED BY	JWR
			APPROVED BY	NKS
PLOT DATE:	\$DATE\$	\$TIME\$	LATE	12-23-2022



This set of plans is not for These plans are intended to build interest in bidding 22 the project.

ISSUED FOR BID 10450 Holmes Road Suite 600 Kansas City, MO 64131-3471 816-360-2700 Certificate of Authority: 000856 NOT FOR CONSTRUCTION

SHEET 4

DRAWING NO.: SHEET NO.: G013 5

	2CHEDOL	E OF INS	PECTION S	EKVICES	
INSPECTION ITEM REQUIRED	FREQUENCY		SPECIFICATION		REMARKS
OTPLICTURAL OTES!	CONTINUOUS	PERIODIC	SECTION	REFERENCE	
STRUCTURAL STEEL					1
VISIT FABRICATION SHOP TO OBSERVE FABRICATION PROCEDURES		•			ONLY ONE INSPECTION IS REQUIRED UNLESS ON-SITE EVENTS INDICATE FURTHER INSPECTIONS ARE NECESSARY
VERIFY FABRICATOR CERTIFICATION		•	SEC 05 12 10 PAR 1.2	IBC 1704.2	
VERIFY CORRECT STRUCTURAL STEEL MATERIAL DELIVERED TO JOB SITE.		•	SEC 05 12 10	IBC 1708.4	
VERIFY JOINT WELD PROCEDURES ARE BEING USED IN ACCORDANCE WITH AWS		•	SEC 05 12 10 PAR 3.1 B	AWS D1.1	
VERIFY CONTRACTOR'S RECEIPT OF WELDER CERTIFICATIONS		•	SEC 05 12 10 PAR 3.1 B	AWS D1.1	
VERIFY CORRECT FILLER MATERIAL USED IN WELDS		•	SEC 05 12 10	AISC LRFD A3.5	
VISUALLY INSPECT ALL WELDS		•			
PROVIDE CONTINUOUS INSPECTION ON ALL FULL OR PARTIAL PENETRATION WELDS AND FILLET WELDS GREATER THAN 5/16"	•				
PERFORM ULTRASONIC TESTING OR MAGNETIC PARTICLE TESTING ON ALL FULL PENETRATION WELDS	•				
PERFORM MAGNETIC PARTICLE TESTING ON 20% OF ALL PARTIAL PENETRATION AND FILLET WELD GREATER THAN 5/16"					
INSPECT STEEL FRAME JOINT DETAILS FOR COMPLIANCE WITH APPROVED CONTRACT		•		IBC 1704.3.2	
VERIFY CORRECT MATERIAL USED HIGH STRENGTH BOLTS, NUTS, AND WASHERS		•		IBC 1704,3,3	
OBSERVE & CHECK TIGHTNESS OF ALL BOLTS IN BEARING CONNECTIONS		•		IBC 1704.3.3 AISC LRFD M2.5	
OBSERVE AND CHECK TORQUE OF ALL BOLTS IN SUP-CRITICAL CONNECTIONS		•		IBC 1704.3.3 AISC LRFD M2.5	
OBSERVE AND TEST ALL FIELD APPLIED HEADED STUDS		•	SEC 05 12 10 PAR 3.1 A 12D	AWS D1.1	VERIFY CORRECT NUMBER, LOCATION, AND WELDING
VISUALLY INSPECT ALL FLOOR DECK AND ROOF DECK WELDS, SCREWS, OR OTHER FASTENERS FOR COMPLIANCE WITH CONTRACTOR		•			

	SCHEDUL	E OF INS	PECTION S	SERVICES	
INSPECTION ITEM REQUIRED	FREQUENCY		SPECIFICATION	CODE	REMARKS
	CONTINUOUS	PERIODIC	SECTION	REFERENCE	
GENERAL					
CONDUCT WEEKLY VISUAL DBSERVATIONS OF THE STRUCTURAL SYSTEMS FOR GENERAL CONFORMANCE TO THE CONSTRUCTION DOCUMENTS AND PREPARE WEEKLY REPORTS OF OBSERVATIONS DESCRIBING WORK PROGRESS AND NON-CONFORMING ITEMS		•		IBC 1704.6	
EARTHWORK, SHALLOW FOUNDATIONS AND SOIL	•		•	•	
VERIFY MATERIALS BELOW SHALLOW FOUNDATIONS ARE ADEQUATE TO ACHIEVE THE DESIGN BEARING CAPACITY	•			IBC 1705.6	ALL FOOTING AND PILE CAP EXCAVATIONS SHALL BE OBSERVED AND APPROVED PRIOR TO CONCRETE PLACEMENT
VERIFY EXCAVATIONS ARE EXTENDED TO PROPER DEPTH AND HAVE REACHED PROPER MATERIAL	•		SEC 31 23 00	IBC 1705.6	ALL FOOTING AND PILE CAP EXCAVATIONS SHALL BE OBSERVED AND APPROVED PRIOR TO CONCRETE PLACEMENT
INSPECT AND OBSERVE PROOF ROLLING OF SUBGRADE PRIOR TO FILL PLACEMENT	•		SEC 31 23 00	IBC 1705.6	
PERFORM CLASSIFICATION AND TESTING OF CONTROLLED FILL MATERIAL		•		IBC 1705.6	TEST EACH SOURCE
VERIFY USE OF PROPER MATERIALS, AND LIFT THICKNESSES DURING PLACEMENT AND COMPACTION OF COMPACTED FILL	•			IBC 1705.6	ONE DENSITY TEST FOR EACH LIFT, DAYS OPERATION, OR 5000 SQ. FT. OF FILL AREA
TESTING AND EVALUATION OF IN-PLACE DENSITY OF COMPACTED FILL AS WORK PROGRESSES	•			IBC 1705.6	ONE DENSITY TEST FOR EACH LIFT, DAYS OPERATION, OR 5000 SQ. FT. OF FILL AREA
INSPECT VAPOR RETARDER FOR CONFORMANCE WITH MANUFACTURES WRITTEN INSTALLATION INSTRUCTIONS		•	SEC 03 31 10		

INCRECTION ITEM DECUIRES	FREQUENCY		SPECIFICATION	CODE	REMARKS
INSPECTION ITEM REQUIRED	CONTINUOUS	DEDIODIC			REMARKS
ONCRETE AND REINFORCING STEEL	CONTINUOUS	PERIODIC	SECTION	REFERENCE	
NSPECT CONCRETE FORMWORK FOR SHAPE,			1	ACI 318	
LOCATION, AND DIMENSIONS OF THE CONCRETE		•		Ch 26.11	
WEMBER BEING FORMED		•		IBC 1705.3	
NSPECT REINFORCING STEEL PRIOR TO CLOSING OF				ACI 318	
THE FORMS AND ARRIVAL OF CONCRETE TO THE		•	SEC 03 22 00	Ch 20, 25.2, 25.3,	
JOBSITE. VERIFY PLACEMENT.		•	020 00 22 00	26.6.1, 26.6.2, 26.6.3 BC 1705.3	
				100 1700,3	
				AWS D1.4	
OBSERVE WELDING OF STEEL REINFORCEMENT	•			ACI 318 Ch 26.6.4	
				IBC 1705.3	
VERIFY CORRECT MATERIAL USED. INCLUDING THE				AWS D1.4	
JSE OF A706 IN WELDED SPLICES, IF ANY		•		ACI 318 Ch 26.6.4 IBC 1705.3	
OBSERVE AND VERIFY PLACEMENT OF ANCHORS,					
BOLTS, AND RODS CAST IN CONCRETE PRIOR TO				ACI 318 Ch 17,8,2, 26,7,1	VISUAL INSPECTION OF ALL BOLTS
CONCRETE PLACEMENT				IBC 1705.3	VIOUNE IN CONTOUT NEED DETO
OBSERVE AND VERIFY PLACEMENT OF OTHER				ACI 240	
EMBEDMENTS CAST IN CONCRETE PRIOR TO	•			ACI 318 Ch 26.8	VISUAL INSPECTION OF ALL EMBEDMENTS
CONCRETE PLACEMENT					
NSPECT POST-INSTALLED ANCHORS INSTALLED				ACI 318	
HORIZONTALLY OR UPWARD. VERIFY PLACEMENT	•			Ch 17.8.2, 26.7.1, 26.7.2	
OCATION AND INSTALLATION PROCEDURES.				IBC 1705.3	
NODE OF THE PART O				ACI 318	
NSPECT POST-INSTALLED ANCHORS INSTALLED DOWNWARD. VERIFY PLACEMENT LOCATION AND				Ch 17.8.2, 26.7.1,	
NSTALLATION PROCEDURES.		•		26.7.2 IBC 1705.3	
EDIEVLIAS AS ARBESTS AND RESTS AND RESIDEN					
VERIFY USE OF CORRECT CONCRETE MIX DESIGN AND REVIEW DELIVERY TICKETS		•	SEC 03 31 00	ACI 318 Ch 26,4	
MAD INCATEM BELIVERY HORETO				01120,4	ADDITIONAL CYLINDERS SHALL BE MADE AS NEED!
				ASTM C172	FOR EARLY FORM REMOVAL, TWO 28 DAY 6X12 OF
SAMPLE FRESH CONCRETE PRIOR TO PLACEMENT. MEASURE SLUMP, AIR CONTENT, AND TEMPERATURE	_		SEC 03.08.13	ASTM C31 ACI 318 Ch 26.4,	THREE 4X8 CYLINDERS ARE REQUIRED FOR AN
DURING CONCRETE DELIVERY.	•		SEC 03.00.13	26.5.3. 26.12	ACCEPTABLE TEST. SINGLE CYLINDER TEST IS
				IBC 1705.3	INADEQUATE FOR STRENGTH EVALUATION PURPOSES
SAMPLE CONCRETE SPECIMENS PRIOR TO					ADDITIONAL CYLINDERS SHALL BE MADE AS NEED
PLACEMENT FOR STRENGTH TESTS TO BE				ASTM C172	FOR EARLY FORM REMOVAL, TWO 28 DAY 6X12 O
PERFORMED IN LAB. A MINIMUM OF FIVE (5)			SEC 03.08.13	ASTM C31 ACI 318 Ch 26.4,	THREE 4X8 CYLINDERS ARE REQUIRED FOR AN
CYLINDERS SHALL BE MADE. TEST TWO AT 7 DAYS	•		SEC 03.00.13	26.5.3, 26.12	ACCEPTABLE TEST, SINGLE CYLINDER TEST IS
AND TWO AT 28 DAYS. THE 5TH CYLINDER SHALL BE HELD IN RESERVE				IBC 1705.3	INADEQUATE FOR STRENGTH EVALUATION PURPOSES
ILLE IN NEGETVE				AOTH 0470	1 014 0020
				ASTM C172 ASTM C31	
PERFORM CONCRETE STRENGTH TESTING		•	SEC 03.08.13	ACI 318 Ch 26.4,	
		•		26.5.3, 26.12	
				IBC 1705.3	
WAINTAIN A SPREADSHEET SHOWING DATE, SEQUENTIAL ORDER OF STRENGTH TEST RESULTS.	_			ACI 318	
AND INDICATE RUNNING AVERAGE	•			Ch 26.11.2(d), 26.11.2(e)	
				ACI 318	
OBSERVE CONCRETE PLACEMENT	•			Ch 26.5.2	
	-			IBC 1705.3	
DOSEDIE DOODED OUDING TEMPEDATUET				ACI 318	
OBSERVE PROPER CURING TEMPERATURE AND TECHNIQUES		•	SEC 03 31 10	Ch 26.5.3, 26.5.4, 26.5.5	
I COM M GOLO		-		IBC 1705.3	
VEDICY THAT THE NEGEODARY REGION STREET				ACI 318	
VERIFY THAT THE NECESSARY DESIGN STRENGTH HAS BEEN REACHED PRIOR TO REMOVAL OF FORMS		•	SEC 03 11 00	Ch 26.11	
				IBC 1705.3	
MEASURE FLOOR FLATNESS AND LEVELNESS AS DIRECTED		•	SEC 03 35 00		INCLUDE UNIT PRICE IN BID PROPOSAL FORM
VERIFY MILL TESTS OF A615 REINFORGING STEEL				ACI 318	
JSED IN SPECIAL MOMENT FRAMES, SPECIAL		•		Ch 20.2.5	
STRUCTURAL WALLS AND COUPLING BEAMS.				BC 1704.5	

REV	DATE	DESCRIPTION	DESIGNED BY	VC
			CHECKED BY	NPK
			DRAWN BY	NPK
			CHECKED BY	VC
			APPROVED BY	NKS
PLOT DATE.	12/21/2022	HelleOO PM		10 07 0000



This set of plans is not for construction.
These plans are intended to build interest in bidding the project.

ISSUED FOR BID

DATE: 12-23-2022

HDR Engineering, Inc.

10450 Holmes Road
Sulte 600
Kansas City, Mo 64131-3471
816-360-2700
Certificate of Authority: 000856

NOT FOR CONSTRUCTION

DATE: 12-23-2022 KANSAS CITY STREETCAR - RIVERFRONT EXTENSION AS SHOWN FILENAME:


AS SHOWN
FILENAME:

CONTRACT NO.:
CONTRACT NO. ***
VOLUME:
I
DRAWING NO.: SHEET NO.:
PS002 198


INSPECTION - IBC 2018


SHEET NOTES:

- ALL EXPOSED STEEL SHALL BE HOT DIP GALVANIZED.
 ALL STEEL ON THIS SHEET SHALL COMPLY TO AESS ARCHITECTURALLY EXPOSED STRUCTURAL STEEL SPECIFICATIONS.

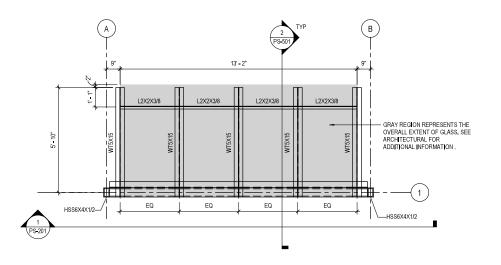

FRAMING PLAN - "TYPE A" SHELTER

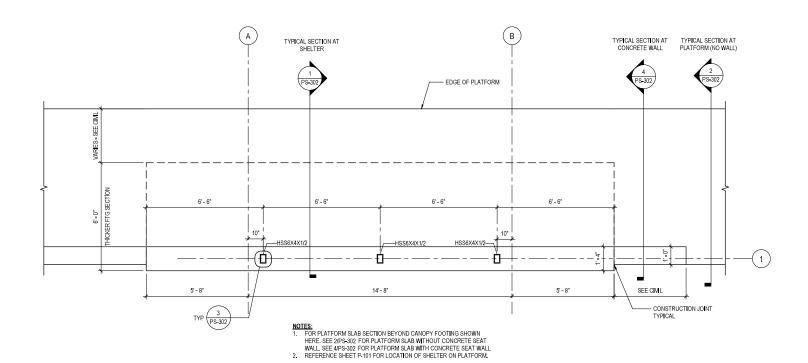

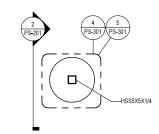

FOUNDATION PLAN - "TYPE A" SHELTER

TYPICAL MARKER FOUNDATION PLAN

REV	DATE	DESCRIPTION		DESIGNED BY	VC	Г
				CHECKED BY	NPK	ı
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				CHECKED BY	VC	
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DIOT DATE.	12/21/2022		IIIII.O2 DM			l

RideKC STREETCAR


not for These plans are tended to build interest in bidding the project.

DATE: 12-23-2022 KANSAS CITY STREETCAR - RIVERFRONT EXTENSION SCALE FOR AS SHOWN FILENAME: ISSUED FOR BID 10450 Holmes Road Suite 600 Kansas City, MO 64131-3471 816-360-2700 Certificate of Authority: 000856 NOT FOR CONSTRUCTION

"TYPE A" SHELTER - FOUNDATION AND FRAMING PLANS

CONTRACT NO.: CONTRACT NO. ***
VOLUME: DRAWING NO.: SHEET NO.: PS101 199

- ALL EXPOSED STEEL SHALL BE HOT DIP GALVANIZED.
 ALL STEEL ON THIS SHEET SHALL COMPLY TO AESS ARCHITECTURALLY EXPOSED STRUCTURAL STEEL SPECIFICATIONS.

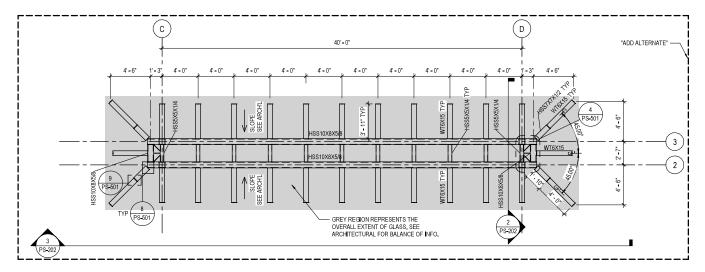

FRAMING PLAN - "TYPE B" SHELTER

40' - 0" 17' - 0" 18"X18" 2KSI GROUT BLOCKOUT IF REQUIRED. FUTURE CHIP AND REMOVAL 0 4 PS-303 TYP 5 PS-303 - EDGE OF PLATFORM NOTES:

1. REFERENCE SHEET P-102 FOR LOCATION OF SHELTER ON PLATFORM.

FOUNDATION PLAN - "TYPE B" SHELTER

REV	DATE	DESCRIPTION		DESIGNED BY	VC	
				CHECKED BY	NPK	
				DRAWN BY	NPK	_
				CHECKED BY	vc	
				APPROVED BY	NKS	1
T DATE:	12/21/2022	e e	04 PM	DATE	12-23-2022	

RideKC STREETCAR

This set of plans is not for These plans are tended to build nterest in bidding the project.

ISSUED FOR BID DATE: 12-23-2022
HDR Engineering, Inc.
10450 Holmes Road
Suite 600
Kansas City, MO 64131-3471
816-360-2700
Certificate of Authority: 000856
NOT FOR CONSTRUCTION


KANSAS CITY STREETCAR - RIVERFRONT EXTENSION SCALE FOR AS SHOWN FILENAME:

"TYPE B" SHELTER - FOUNDATION AND FRAMING PLANS

CONTRACT NO.: CONTRACT NO. ***
VOLUME: DRAWING NO.: SHEET NO.: PS102 200

SHEET NOTES:

- ALL EXPOSED STEEL SHALL BE HOT DIP GALVANIZED.
 ALL STEEL ON THIS SHEET SHALL COMPLY TO AESS ARCHITECTURALLY EXPOSED STRUCTURAL STEEL SPECIFICATIONS.

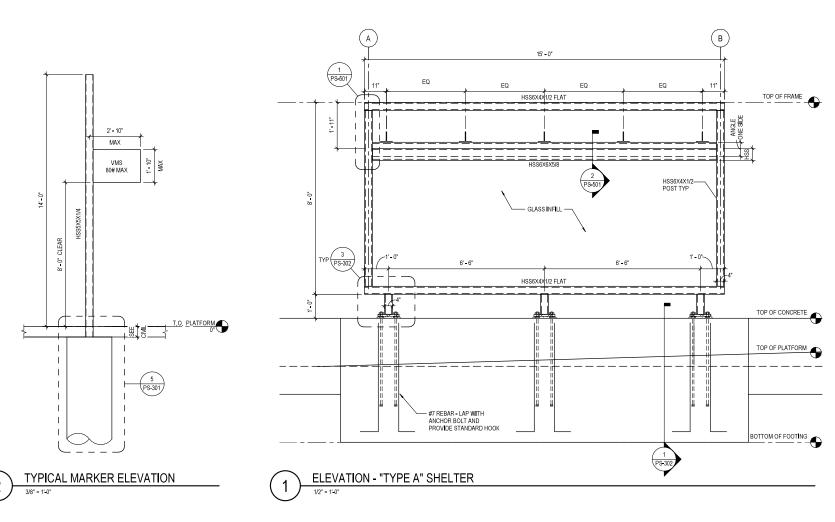

CHECKED BY PROVED BY PLOT DATE: 12/21/2022 II:II:06 PM DATE

RideKC STREETCAR

This set of plans is not for construction. These plans are tended to build interest in bidding the project.


ISSUED FOR BID 10450 Holmes Road Suite 600 Kansas City, MO 64131-3471 816-360-2700 Certificate of Authority: 000856 NOT FOR CONSTRUCTION


"TYPE A" SHELTER - SECTIONS AND **ELEVATIONS**


DATE: 12-23-2022 KANSAS CITY STREETCAR - RIVERFRONT EXTENSION AS SHOWN FILENAME: CONTRACT NO.: CONTRACT NO. ***
VOLUME: DRAWING NO.: SHEET NO.: PS201 201

SHEET NOTES:

- ALL EXPOSED STEEL SHALL BE HOT DIP GALVANIZED.
 ALL STEEL ON THIS SHEET SHALL COMPLY TO AESS ARCHITECTURALLY EXPOSED STRUCTURAL STEEL SPECIFICATIONS.

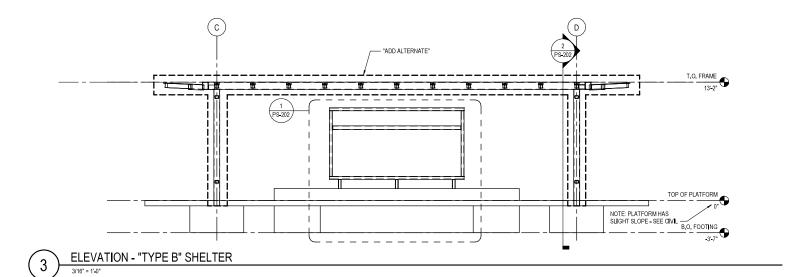

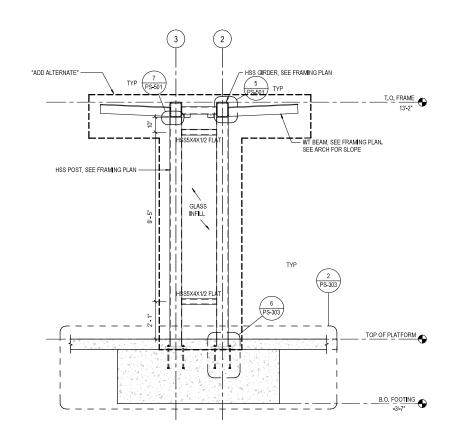

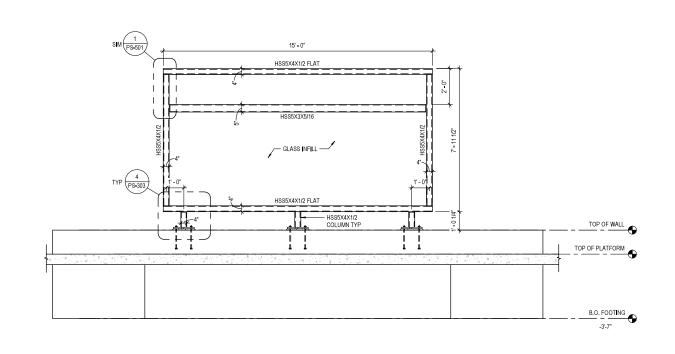

SECTION - "TYPE B" SHELTER

ELEVATION - "TYPE B" SHELTER

REV	DATE	DESCRIPTION			DESIGNED BY	VC	
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					DRAWN BY	NPK	
					CHECKED BY	vc	9
					APPROVED BY	NKS	′
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PLOT DATE:	12/21/2022		80:11:11	РМ	DATE	12-23-2022	


RideKC STREETCAR


These plans are tended to build nterest in bidding the project.

DATE: 12-23-2022 KANSAS CITY STREETCAR - RIVERFRONT EXTENSION SCALE FOR AS SHOWN FILENAME: ISSUED FOR BID 10450 Holmes Road Suite 600 Kansas City, MO 64131-3471 816-360-2700 Certificate of Authority: 000856 NOT FOR CONSTRUCTION


"TYPE B" SHELTER - SECTIONS AND **ELEVATIONS**

CONTRACT NO.: CONTRACT NO. ***
VOLUME: DRAWING NO.: SHEET NO.: PS202 202

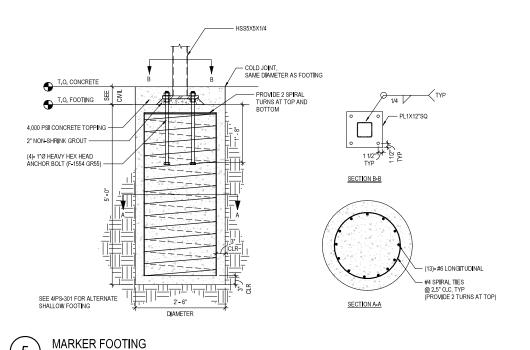

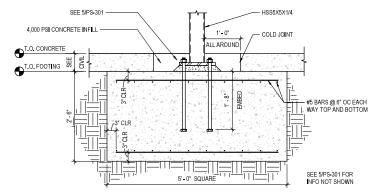


MARKER FOOTING - ALTERNATE SHALLOW FOOTING

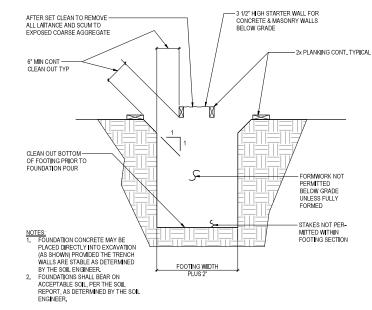

TYPICAL FOOTING FORMING DETAIL

"d" BAR DIAMETER

"D" = BAR BEND DIAMETER 6d FOR #3 THRU #8 8d FOR #9, #10, AND #11

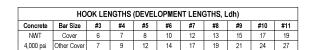

- NOTES:

 1. ALL LENGTHS ARE IN INCHES.
 2. COVER BARS ARE BARS WITH AT LEAST 2 1/2 IN OF SIDE COVER TO HOOK
- AND 2 IN OF COVER BEYOND HOOK EXTENSION (TAIL).

TYPICAL REINFORCING SCHEDULE

3. REFER TO ACI 318-14.

CLASS A SPLICE LENGTHS (DEVELOPMENT LENGTHS, Ld)

Concrete	Bar Size	#3	#4	#5	#6	#7	#8	#9	#10	#11
NWT	Top Bar	18	25	31	37	54	62	70	78	87
4,000 psi	Other Bar	14	19	24	28	42	47	54	60	67

CLASS B SPLICE LENGTHS (TENSION LAP LENGTHS, Lst = 1.3Ld)										
Concrete	Bar Size	#3	#4	#5	#6	#7	#8	#9	#10	#11
NWT	Top Bar	24	32	40	48	70	80	90	102	113
4,000 psi	Other Bar	18	25	31	37	54	62	70	78	87

- NOTES:

 1. ALL LENGTHS ARE IN INCHES, FOR EPOXY COATED MULTIPLY VALUES BY 1.5 TIMES. 2. TOP BARS ARE HORIZONTAL BARS WITH MORE THAN 12 INCHES OF CONCRETE BELOW THEM.
- WALL BARS ARE NOT CONSIDERED TOP BARS.
 USE CLASS B SPLICES TYPICALLY, UNO.
- 5. REFER TO ACI 318-14.



TYPICAL REINFORCING CONFIGURATION

ESIGNED BY DATE DESCRIPTION HECKED BY PROVED BY PLOT DATE: 12/21/2022 II:II:IO PM DATE

RideKC **STREETCAR**

not for These plans are tended to build nterest in bidding the project.

DATE: 12-23-2022 KANSAS CITY STREETCAR - RIVERFRONT EXTENSION SCALE FOR AS SHOWN FILENAME: SSUED FOR BID 10450 Holmes Road Suite 600 Kansas City, MO 64131-3471 816-360-2700 Certificate of Authority: 000856 NOT FOR CONSTRUCTION

TYPICAL CONCRETE DETAILS

NOTE: CAP STIRRUPS MAY BE USED IN BEAMS UNO

—ALTERNATE CAP DIRECTION IF SLAB OCCURS BOTH SIDES OF BEAM OR LOCATE 90 DEG BEND TYP ON SLAB SIDE WHERE SLAB OCCURS ONLY ONE SIDE. IF NO SLAB OCCURS ETHER SIDE PROVIDE 135 DEG. BEND ON EACH SIDE. 90 DEG BEND

--- 135 DEG

NOTE: ALL HOOKS, BENDS, AND LAPS SHALL BE INDICATED UNO


CONTRACT NO.: CONTRACT NO. ***
VOLUME: DRAWING NO.: SHEET NO.: PS301 203


135 DEG BEND


CLASS A OR B SPLICE


SEE REINF SCHEDULE

- WIRE REINFORCING TOGETHER - TYP

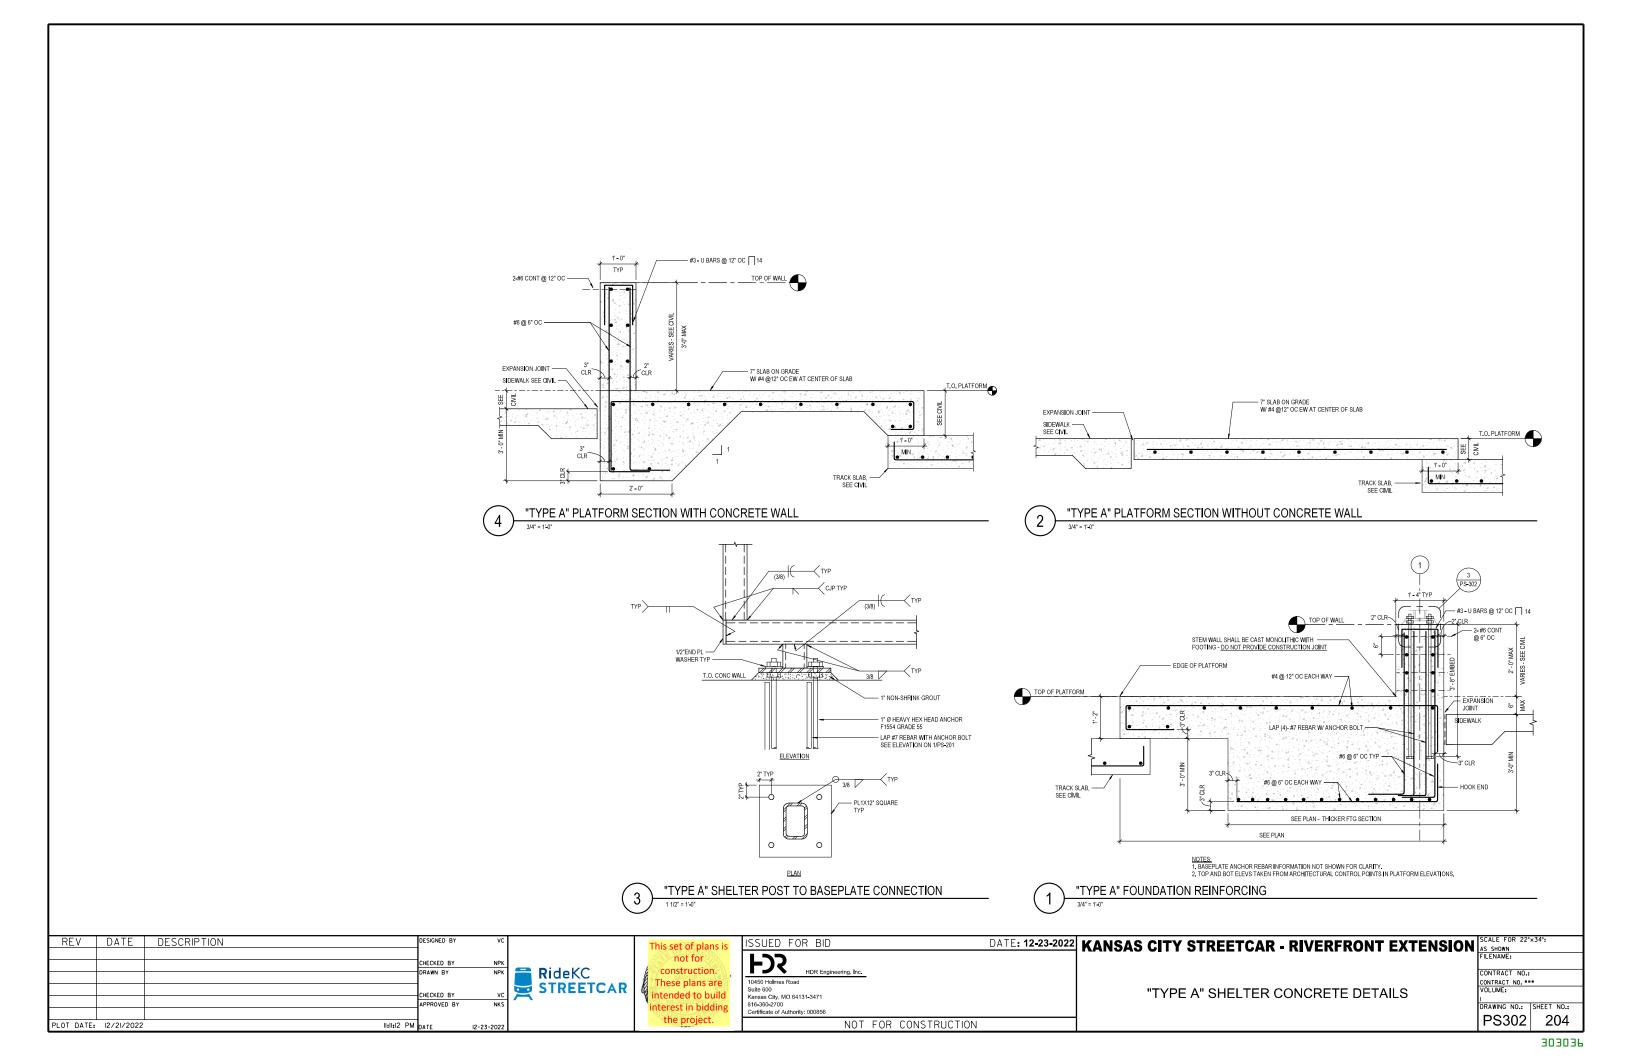

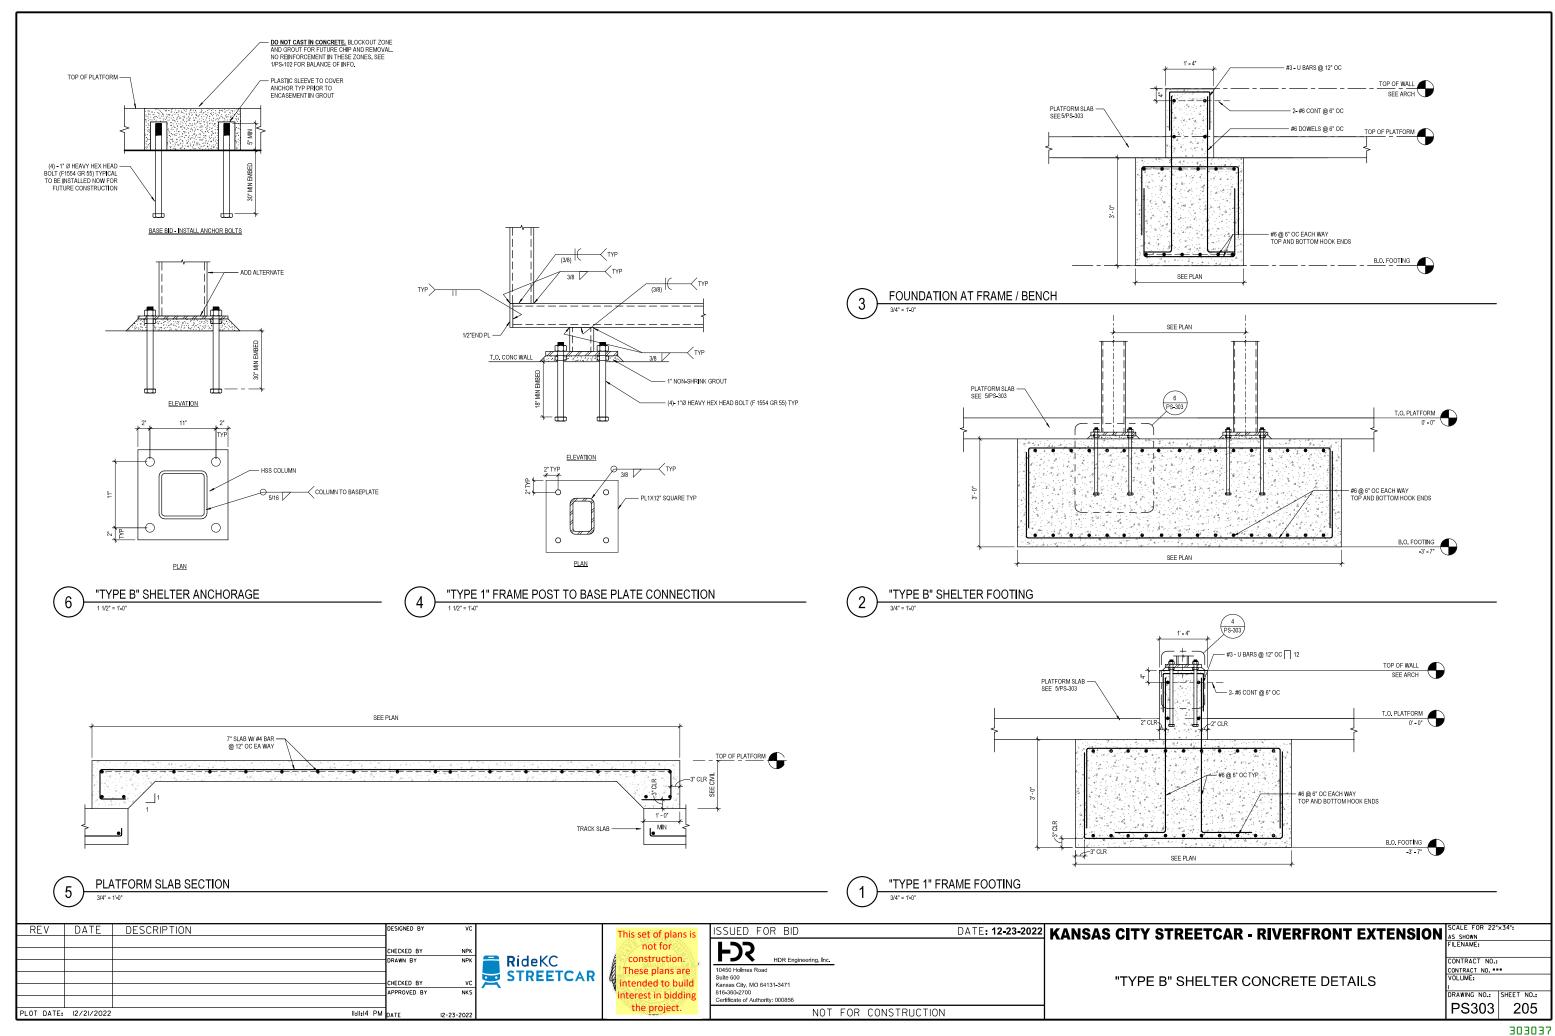

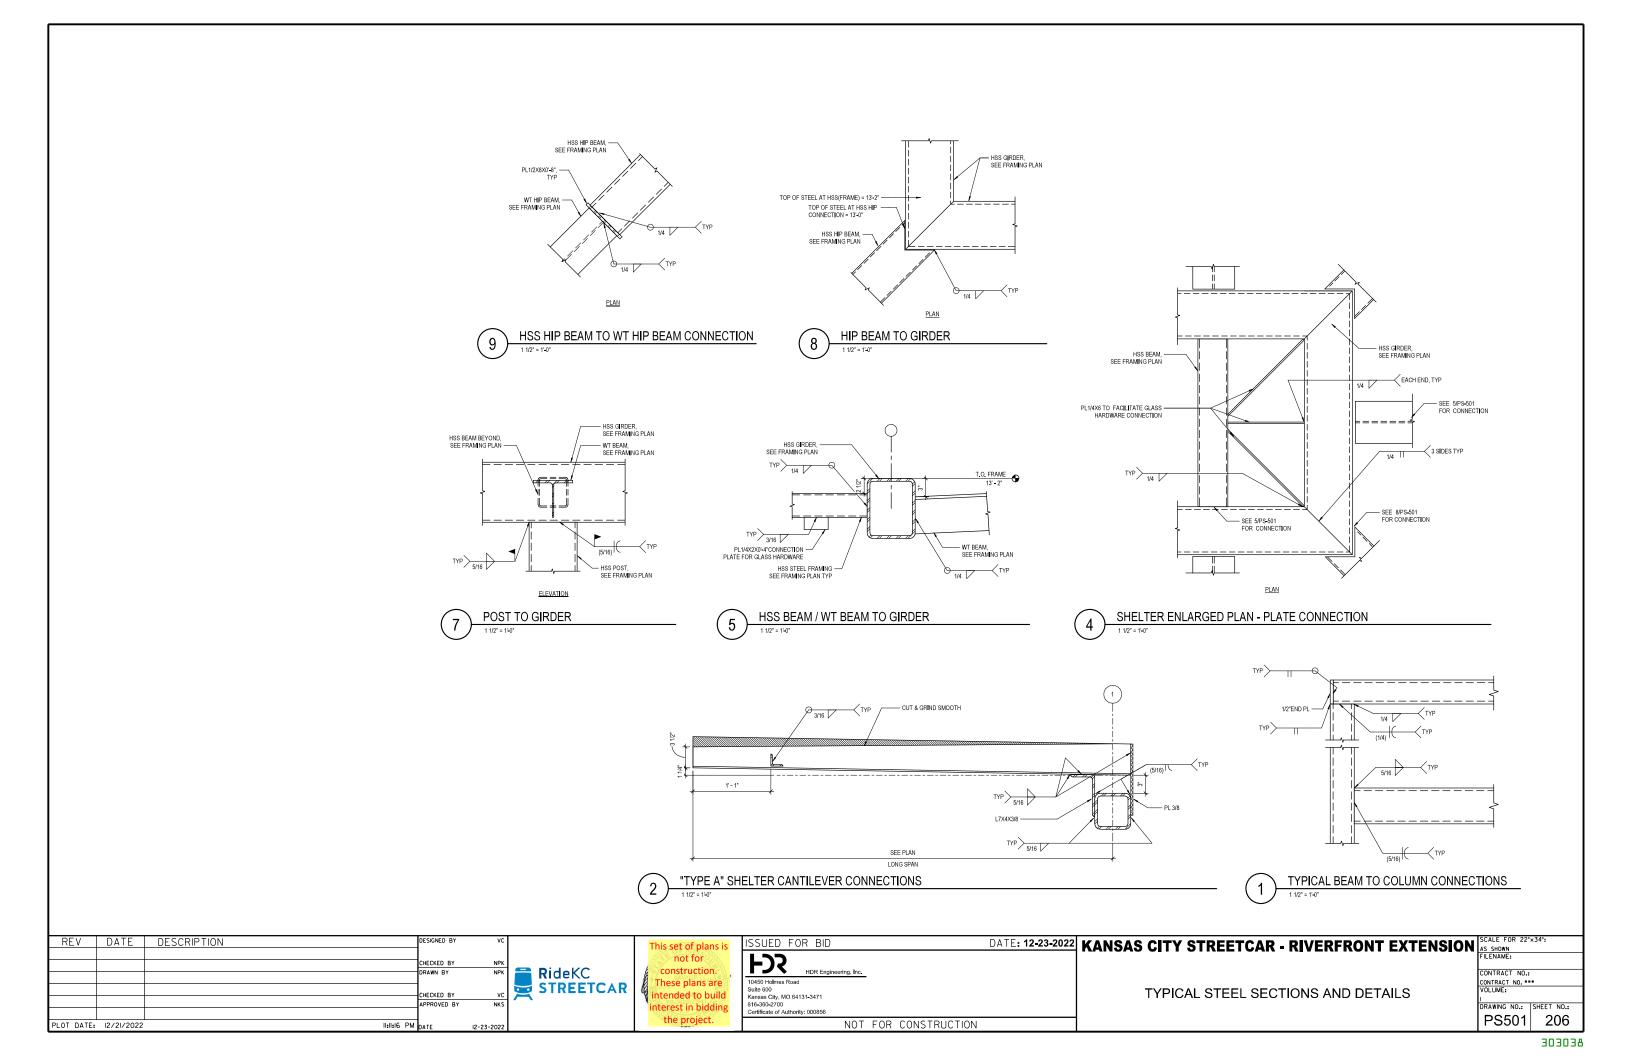

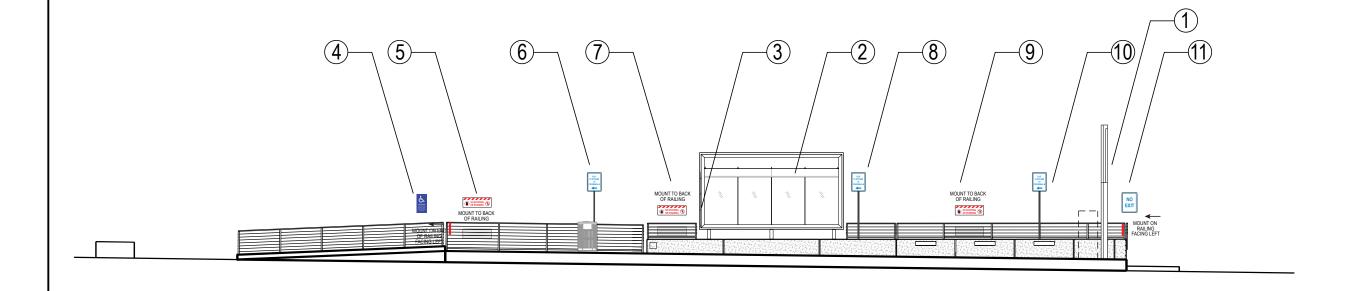

ELEVATION: STANDARD STOP SIGNAGE RIVER MARKET NORTH (SB) P501

NOTE: SIGN TYPE B IS ON BOTH SIDES OF THE "FRAME".

SIGN LOCATION	SIGN TYPE	SIGN MESSAGE
1	A1-A4	A1: RIVER MARKET NORTH A2-A4: SEE DETAILS
2	В	< RIVERFRONT RIVER MARKET NORTH RIVER MARKET NORTH < RIVERFRONT
	В	RIVERFRONT > RIVER MARKET NORTH RIVER MARKET NORTH RIVERFRONT >
3	Е	SEE DETAIL
4	K	SEE DETAIL
5	J	SEE DETAIL
6	Н	SEE DETAIL
7	J	SEE DETAIL
8	Н	SEE DETAIL
7	J H	SEE DETAIL

RideKC

STREETCAR

SIGN LOCATION	SIGN TYPE	SIGN MESSAGE
9	J	SEE DETAIL
10	Н	SEE DETAIL
11	F	SEE DETAIL
12	G	SEE DETAIL AND WAYFINDING PLAN SHEET P507
13	G	SEE DETAIL AND WAYFINDING PLAN SHEET P507
14	G	SEE DETAIL AND WAYFINDING PLAN SHEET P507
15	G	SEE DETAIL AND WAYFINDING PLAN SHEET P507

PLOT DATE: 12/21/2022

- DO NOT SCALE DRAWINGS, IF DIMENSIONAL INFORMATION IS REQUIRED & NOT FOUND, NOTIFY ARCHITECT IMMEDIATELY FOR CLARIFICATION.

 REFER TO DRAWINGS (SERIES P500) AND SPECIFICATIONS (SECTION 10 14 03) FOR COMPLETE INFORMATION.

 ALL SPECIFIED MATERIALS AND METHODS SHALL BE REVIEWED FOR CONFORMANCE WITH ADA GUIDELINES. NOTIFY ARCHITECT OF ANY ITEMS THAT DO NOT CONFORM PRIOR TO FABRICATION.

 SIGN TYPE USE FOR ALL LOCATIONS SHOWN SHALL BE CONFIRMED TO AS-BUILT CONDITIONS AND CONFIRMED WITH THE OWNER PRIOR TO PRODUCTION.
- MESSAGE TEXT FOR ALL LOCATIONS SHOWN SHALL BE CONFIRMED TO AS-BUILT CONDITIONS AND CONFIRMED WITH THE OWNER PRIOR TO PRODUCTION. COORDINATE WITH ARCHITECTURAL DETAILING IN P200 AND P300 SERIES DRAWINGS.

This set of plans is	ISSUED
not for construction.	FD3
These plans are intended to build	10450 Holmes F Suite 600 Kansas City, MC


interest in bidding 22 the project.

ISSUED FOR BID			DATE: 12-23-2022	
HDR Engineering, Inc. 10450 Holmes Road Sulte 600 Kansas City, MO 64131-3471 816-360-2700				
Certificate of Authority: 000856				
NOT	FOR	CONSTRUCTION		

J	10	IJ

KANSAS CITY STREETCAR - RIVERFRONT EXTENSION "RIVER MARKET NORTH" PLATFORM SIGNAGE LOCATION ELEVATION

Ш	SCALE FUR 22	XJ4:					
	I' = 5'						
	FILENAME:						
	P50l.dgn						
	CONTRACT NO .:						
	CONTRACT NO. ***						
	VOLUME:						
	l .						
	DRAWING NO.:	SHEET NO.:					
	P501	207					
	F301	207					

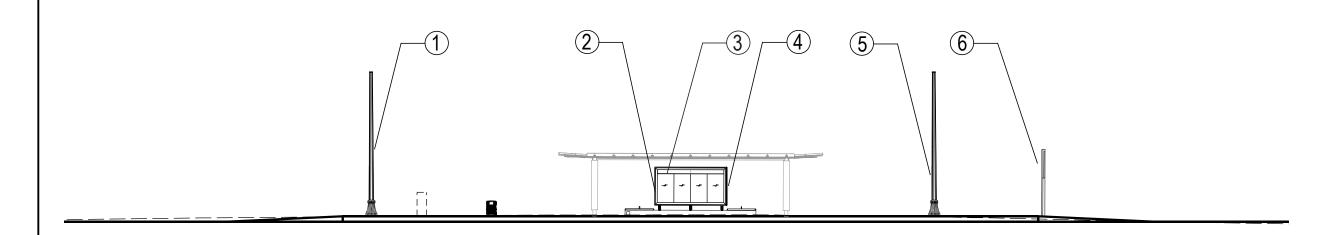

ELEVATION: STANDARD STOP SIGNAGE RIVERFRONT

SIGN LOCATION	SIGN TYPE	SIGN MESSAGE
1	С	SEE DETAIL
2	D	SEE DETAIL
3	В	< UMKC RIVERFRONT RIVERFRONT < UMKC
	В	UMKC> RIVERFRONT RIVERFRONT UMKC>
4	D	SEE DETAIL
5	С	SEE DETAIL
6	A1-A4	A1: RIVERFRONT A2-A4: SEE DETAILS

NOTE: SIGN TYPE B IS ON BOTH SIDES OF THE "FRAME".

- DO NOT SCALE DRAWINGS, IF DIMENSIONAL INFORMATION IS REQUIRED & NOT FOUND, NOTIFY ARCHITECT IMMEDIATELY FOR CLARIFICATION.

 REFER TO DRAWINGS (SERIES P500) AND SPECIFICATIONS (SECTION 10 14 03) FOR COMPLETE INFORMATION.

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- MESSAGE TEXT FOR ALL LOCATIONS SHOWN SHALL BE CONFIRMED TO AS-BUILT CONDITIONS AND CONFIRMED WITH THE OWNER PRIOR TO PRODUCTION. COORDINATE WITH ARCHITECTURAL DETAILING IN P200 AND P300 SERIES DRAWINGS.

SCALE	
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PLOT DATE:	12/21/2022	7:56:30	PM DATE	12-23-2022		


RideKC TREETCAR


not for construction. These plans are intended to build interest in bidding 22 NCHO the project.


ISSUED FOR BID			DATE: 12-23-2022
HDR Engineering, Inc. 10450 Holmes Road Sulte 600 Kansas City, MO 64131-3471 816-330-2700 Certificate of Authority: 000856			
NOT	FOR	CONSTRUCTION	


"RIVERFRONT" PLATFORM SIGNAGE LOCATION ELEVATION

KANSAS CITY STREETCAR - RIVERFRONT EXTENSION | SCALE FOR | FILENAME: P502.dgn CONTRACT NO.: CONTRACT NO. ***
VOLUME: DRAWING NO.: SHEET NO.: P502

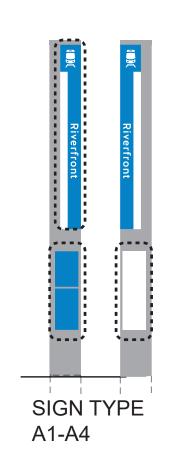

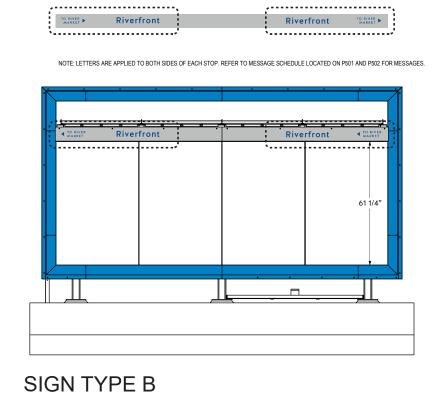

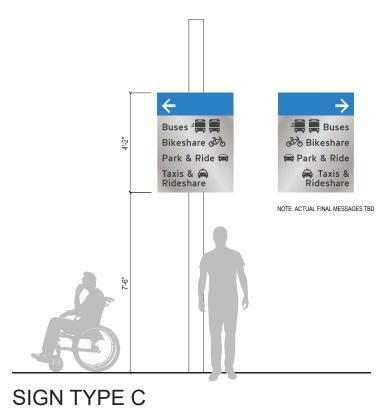

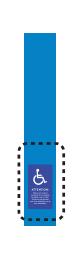



SIGN TYPE D

SIGN TYPE E

- DO NOT SCALE DRAWINGS, IF DIMENSIONAL INFORMATION IS REQUIRED & NOT FOUND, NOTIFY THE ARCHITECT IMMEDIATELY FOR CLARIFICATION.
- ORIGINAL ADOBE ILLUSTRATOR ARTWORK SHALL BE PROVIDED TO MANUFACTURERS.
 MESSAGE TEXT FOR ALL SIGN TYPES SHALL BE COORDINATED WITH THE OWNER PRIOR TO FABRICATION.
- MESSAGE SCHEDULE (APPENDIX 10 14 06a), LOCATION PLANS (AG SERIES), SPECIFICATIONS (SECTION 10 14 06) AND DRAWING SHEETS (AG SERIES) SHALL BE COORDINATED FOR COMPLETE INFORMATION.
- MESSAGE SCHEDULE (APPENDIX 10 14 06a), LOCATION PLANS (AG SERIES), SPECIFICATIONS (SECTION 10 14 06) AND DRAWING SHEETS (AG SERIES) SHALL BE CONFIRMED TO AS-BUILT CONDITIONS PRIOR TO PRODUCTION. ALL SPECIFIED MATERIALS AND METHODS SHALL BE REVIEWED FOR CONFORMANCE WITH ADA GUIDELINES. NOTIFY THE ARCHITECT OF ANY ITEMS THAT DO NOT CONFORM PRIOR TO FABRICATION.
 INITIAL INSERTS TO BE PROVIDED BY THE MANUFACTURER.

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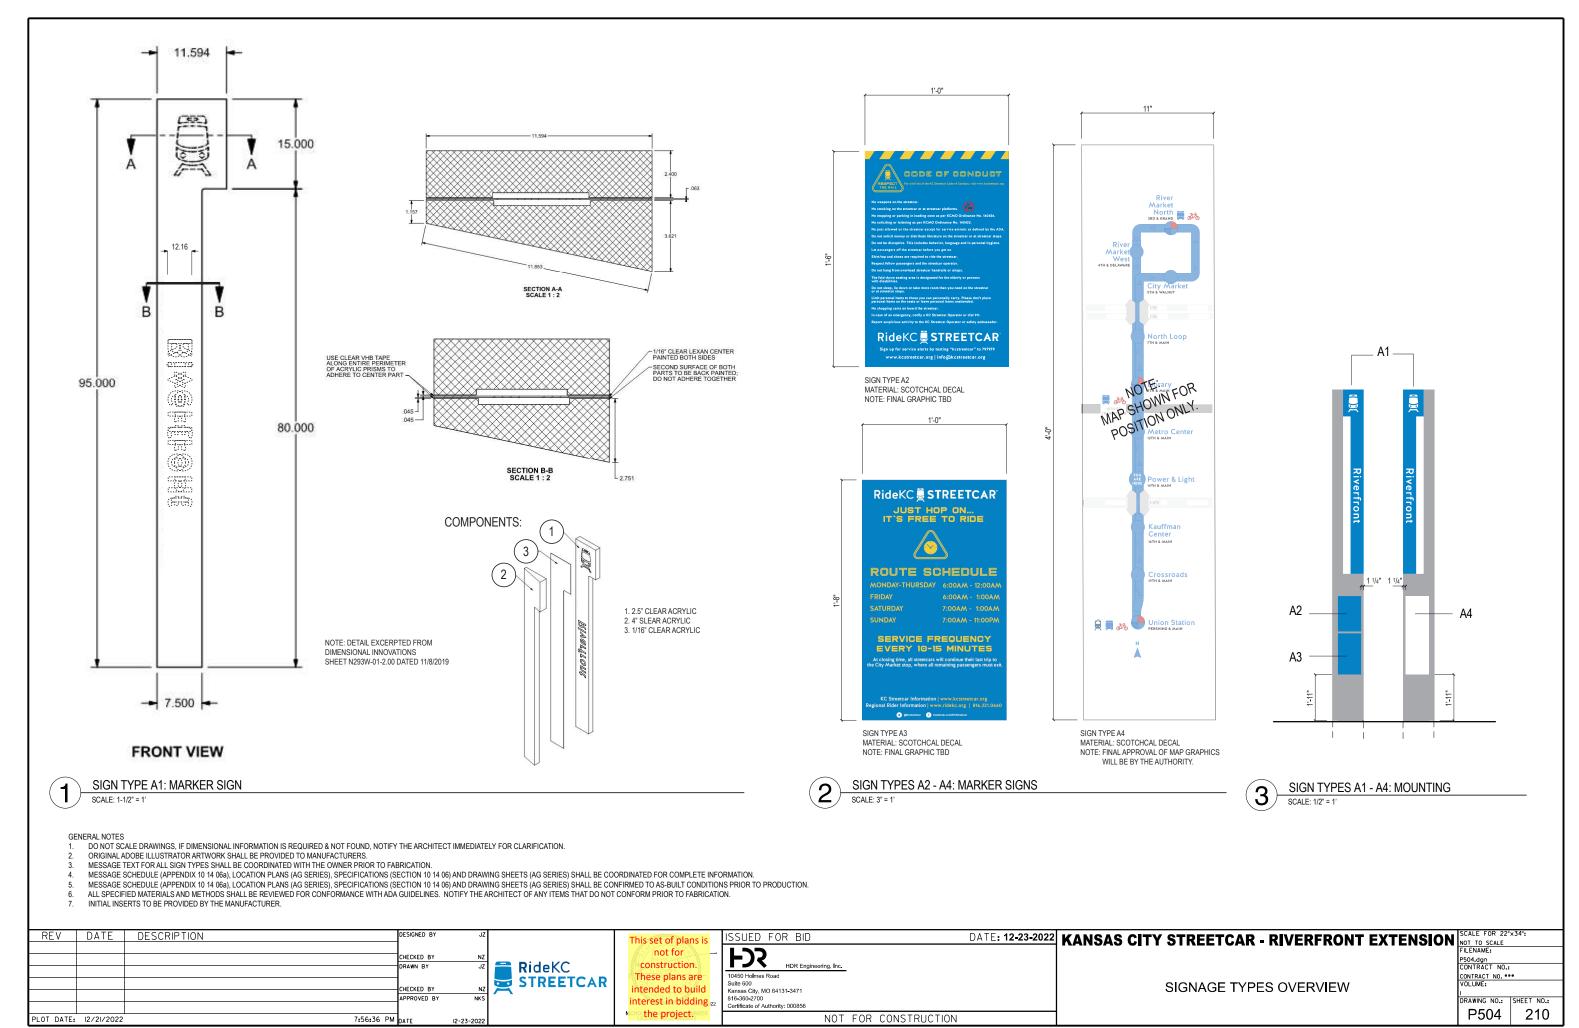
not for These plans are intended to build nterest in bidding the project.

ISSUED FOR BID 10450 Holmes Road Suite 600 Kansas City, MO 64131-3471 816-360-2700 Certificate of Authority: 000856 NOT FOR CONSTRUCTION

DATE: 12-23-2022 KANSAS CITY STREETCAR - RIVERFRONT EXTENSION NOT TO SCALE FILENAME:

SIGNAGE TYPES OVERVIEW

P503.dgn CONTRACT NO.: CONTRACT NO. ***
VOLUME: DRAWING NO.: SHEET NO.: P503






SIGN TYPE B: SHELTER SIGNS SCALE: 1-1/2" = 1'




ATTACHMENT BRACKET ISOMETRIC VIEW

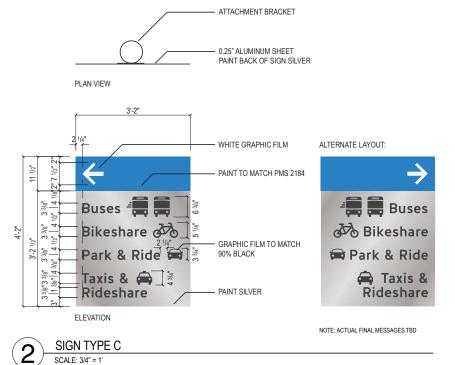



SCALE: 3" = 1'

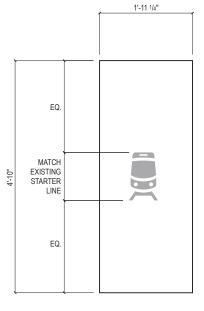

MATERIAL: 3M DUSTED CRYSTAL GRAPHIC FILM, SECOND SURFACE



- DO NOT SCALE DRAWINGS, IF DIMENSIONAL INFORMATION IS REQUIRED & NOT FOUND, NOTIFY THE ARCHITECT IMMEDIATELY FOR CLARIFICATION.
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 INITIAL INSERTS TO BE PROVIDED BY THE MANUFACTURER.

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ı	PLOT DATE:	12/21/2022		7:56:39 PM	DATE	12-23-2022			

This set of plans is not for construction. These plans are intended to build interest in bidding the project.

ISSUED FOR BID **FD3** 10450 Holmes Road Suite 600 Kansas City, MO 64131-3471 816-360-2700 Certificate of Authority: 000856 NOT FOR CONSTRUCTION

DATE: 12-23-2022 KANSAS CITY STREETCAR - RIVERFRONT EXTENSION | SCALE FOR 22 | NOT TO SCALE FILENAME:

SIGNAGE TYPES OVERVIEW

P505.dgn CONTRACT NO.: CONTRACT NO. ***
VOLUME: DRAWING NO.: SHEET NO.: P505 211



NOTES: MATERIAL: 1/8" ALUMINUM PROCESS: DIRECT-PRINTED GRAPHICS ON REFLECTIVE SHEET HDR WILL PROVIDE DIGITAL



ALTERNATE LAYOUTS(NOT TO SCALE): **STREETCAR ACCESS**



MATERIAL: 1/8" ALUMINUM PROCESS: DIRECT-PRINTED GRAPHICS ON REFLECTIVE SHEET HDR WILL PROVIDE DIGITAL



MATERIAL: 1/8" ALUMINUM PROCESS: DIRECT-PRINTED GRAPHICS ON REFLECTIVE SHEET HDR WILL PROVIDE DIGITAL

SIGN TYPE H SCALE: 3/4" = 1'







MATERIAL: 1/8" ALUMINUM PROCESS: DIRECT-PRINTED
GRAPHICS ON REFLECTIVE SHEET HDR WILL PROVIDE DIGITAL ARTWORK FILES



- DO NOT SCALE DRAWINGS, IF DIMENSIONAL INFORMATION IS REQUIRED & NOT FOUND, NOTIFY THE ARCHITECT IMMEDIATELY FOR CLARIFICATION.
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MATERIAL: 1/8" ALUMINUM PROCESS: DIRECT-PRINTED
GRAPHICS ON REFLECTIVE SHEET
HDR WILL PROVIDE DIGITAL

ELEVATION



REV	DATE	DESCRIPTION		DESIGNED BY	JZ		
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				APPROVED BY	NKS		
PLOT DATE:	12/21/2022		7:56:4I PM	DATE	12-23-2022		

This set of plans is not for construction. These plans are intended to build interest in bidding 22 the project.

ISSUED FOR BID **FD3** 10450 Holmes Road Suite 600 Kansas City, MO 64131-3471 816-360-2700 Certificate of Authority: 000856 NOT FOR CONSTRUCTION

DATE: 12-23-2022 KANSAS CITY STREETCAR - RIVERFRONT EXTENSION | SCALE FOR 22 | NOT TO SCALE FILENAME:

SIGNAGE TYPES OVERVIEW

P506.dgn CONTRACT NO.: CONTRACT NO. ***
VOLUME: DRAWING NO.: SHEET NO.: P506 212

